WEST

ARCHITECTURE

318 SOUTH DIXIE HIGHWAY

SUITE 4-5 LAKE WORTH FL 33460

561-588-2027 T 561-582-9419 F

www.west-arch.com

CONSULTANT

+ DESIGN, LLC AA26001503



DESIGN-BUILD FOR:

# HALLANDALE COMMONS

301-323 FOSTER RD. HALLANDALE BEACH, FL

### PROJECT TEAM:

#### **OWNER:**

HALLANDALE BEACH CRA 400 N. FEDERAL HIGHWAY HALLANDALE BEACH, FL (954) 457 2228

## **DEVELOPER:**

DONALDSON-WEST VENTURE, LLC 318 S. DIXIE HIGHWAY, SUITE 4-5 LAKE WORTH, FL 33460 (215) 869-9233

#### **GENERAL CONTRACTOR:**

WEST CONSTRUCTION, INC 318 S DIXIE HIGHWAY, SUITE 4-5 LAKE WORTH, FLORIDA 33460 (561) 588 2027

#### **ARCHITECT:**

WEST ARCHITECTURE + DESIGN, LLC 318 S DIXIE HIGHWAY, SUITE 4-5 LAKE WORTH, FLORIDA 33460 (561) 588 2027

#### **CIVIL ENGINEER:**


GLOBE ENGINEERING, INC. 4839 SW 148 AVENUE, SUITE 507 FORT LAUDERDALE, FL (954) 316-7628

#### LANDSCAPE ARCHITECT:

BRUCE E. CUMMINGS, P.A. 235 COMMERCIAL BOULEVARD, SUITE 203 LAUDERDALE-BY-THE-SEA, FLORIDA (954) 771-8184

#### PROJECT SCOPE:

DESIGNED IN MID-CENTURY MODERN ARCHITECTURE STYLE. THIS PROJECT CONSISTS OF 3 BUILDINGS WITH 10 TOWNHOUSE UNITS IN A RESIDENTIAL AREA. THE 0.54 ACRE SITE IS LOCATED RIGHT ON FOSTER ROAD WITH A TOTAL 15,944 SF LIVING SPACE. FACADE WAS ARTICULATED TO CREATE A PEDESTRIAN SCALE WITH VARIETY OF MATERIALS. THE MODULATION OF FACADE SURFACE BOTH HORIZONTAL AND VERTICAL CREATES HIERARCHY OF ELEMENTS DEFINING THE INTERIOR SPACES. THE PROJECT ALSO INCLUDES SITE DESIGN AND ALL THE ASSOCIATED ELEMENTS.

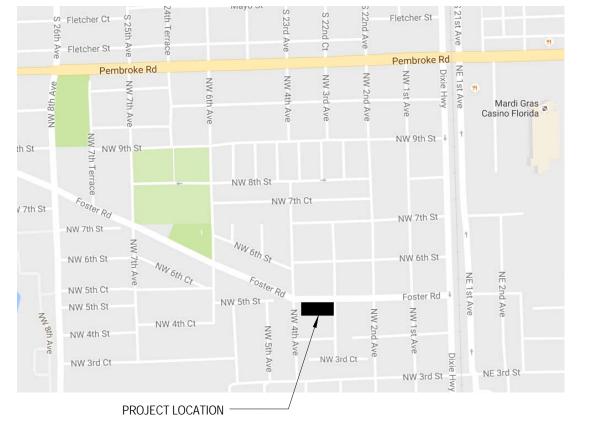

#### KEY PLAN 1" = 300'-0"

## SHEET INDEX:

A-0.00 COVER SHEET AC-1.00 BUILDING CODE INFORMATION + LIFE SAFETY PLAN + AREA CALCULATIONS AS-1.00 ARCHITECTURAL SITE PLAN AS-1.10 ARCHITECTURAL SITE PLAN DETAILS AS-1.20 SITE PHOTOMETRICS C-1 PAVING, DRAINAGE, WATER AND SEWER PLAN C-2 CIVIL ENGINEERING DETAILS C-3 CIVIL ENGINEERING DETAILS LANDSCAPE L-1 LANDSCAPE PLAN ARCHITECTURAL A-1.00 OVERALL FLOOR PLANS A-1.10 UNIT TYPE "A" FLOOR PLANS A-1.20 UNIT TYPE "B" FLOOR PLANS

A-1.30 ROOF PLAN

A-2.10 RENDERINGS

A-2.00 EXTERIOR ELEVATIONS

301-323 FOSTER RD. HALLANDALE BEACH FL

DESIGN & BUILD FOR

COMMONS

**HALLANDALE** 

NUMBER: A16-011 REVIEWED: MFW MANAGED: PG BG DRAWN:


03-16-2017

REVISION:

DATE:

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**COVER SHEET** 

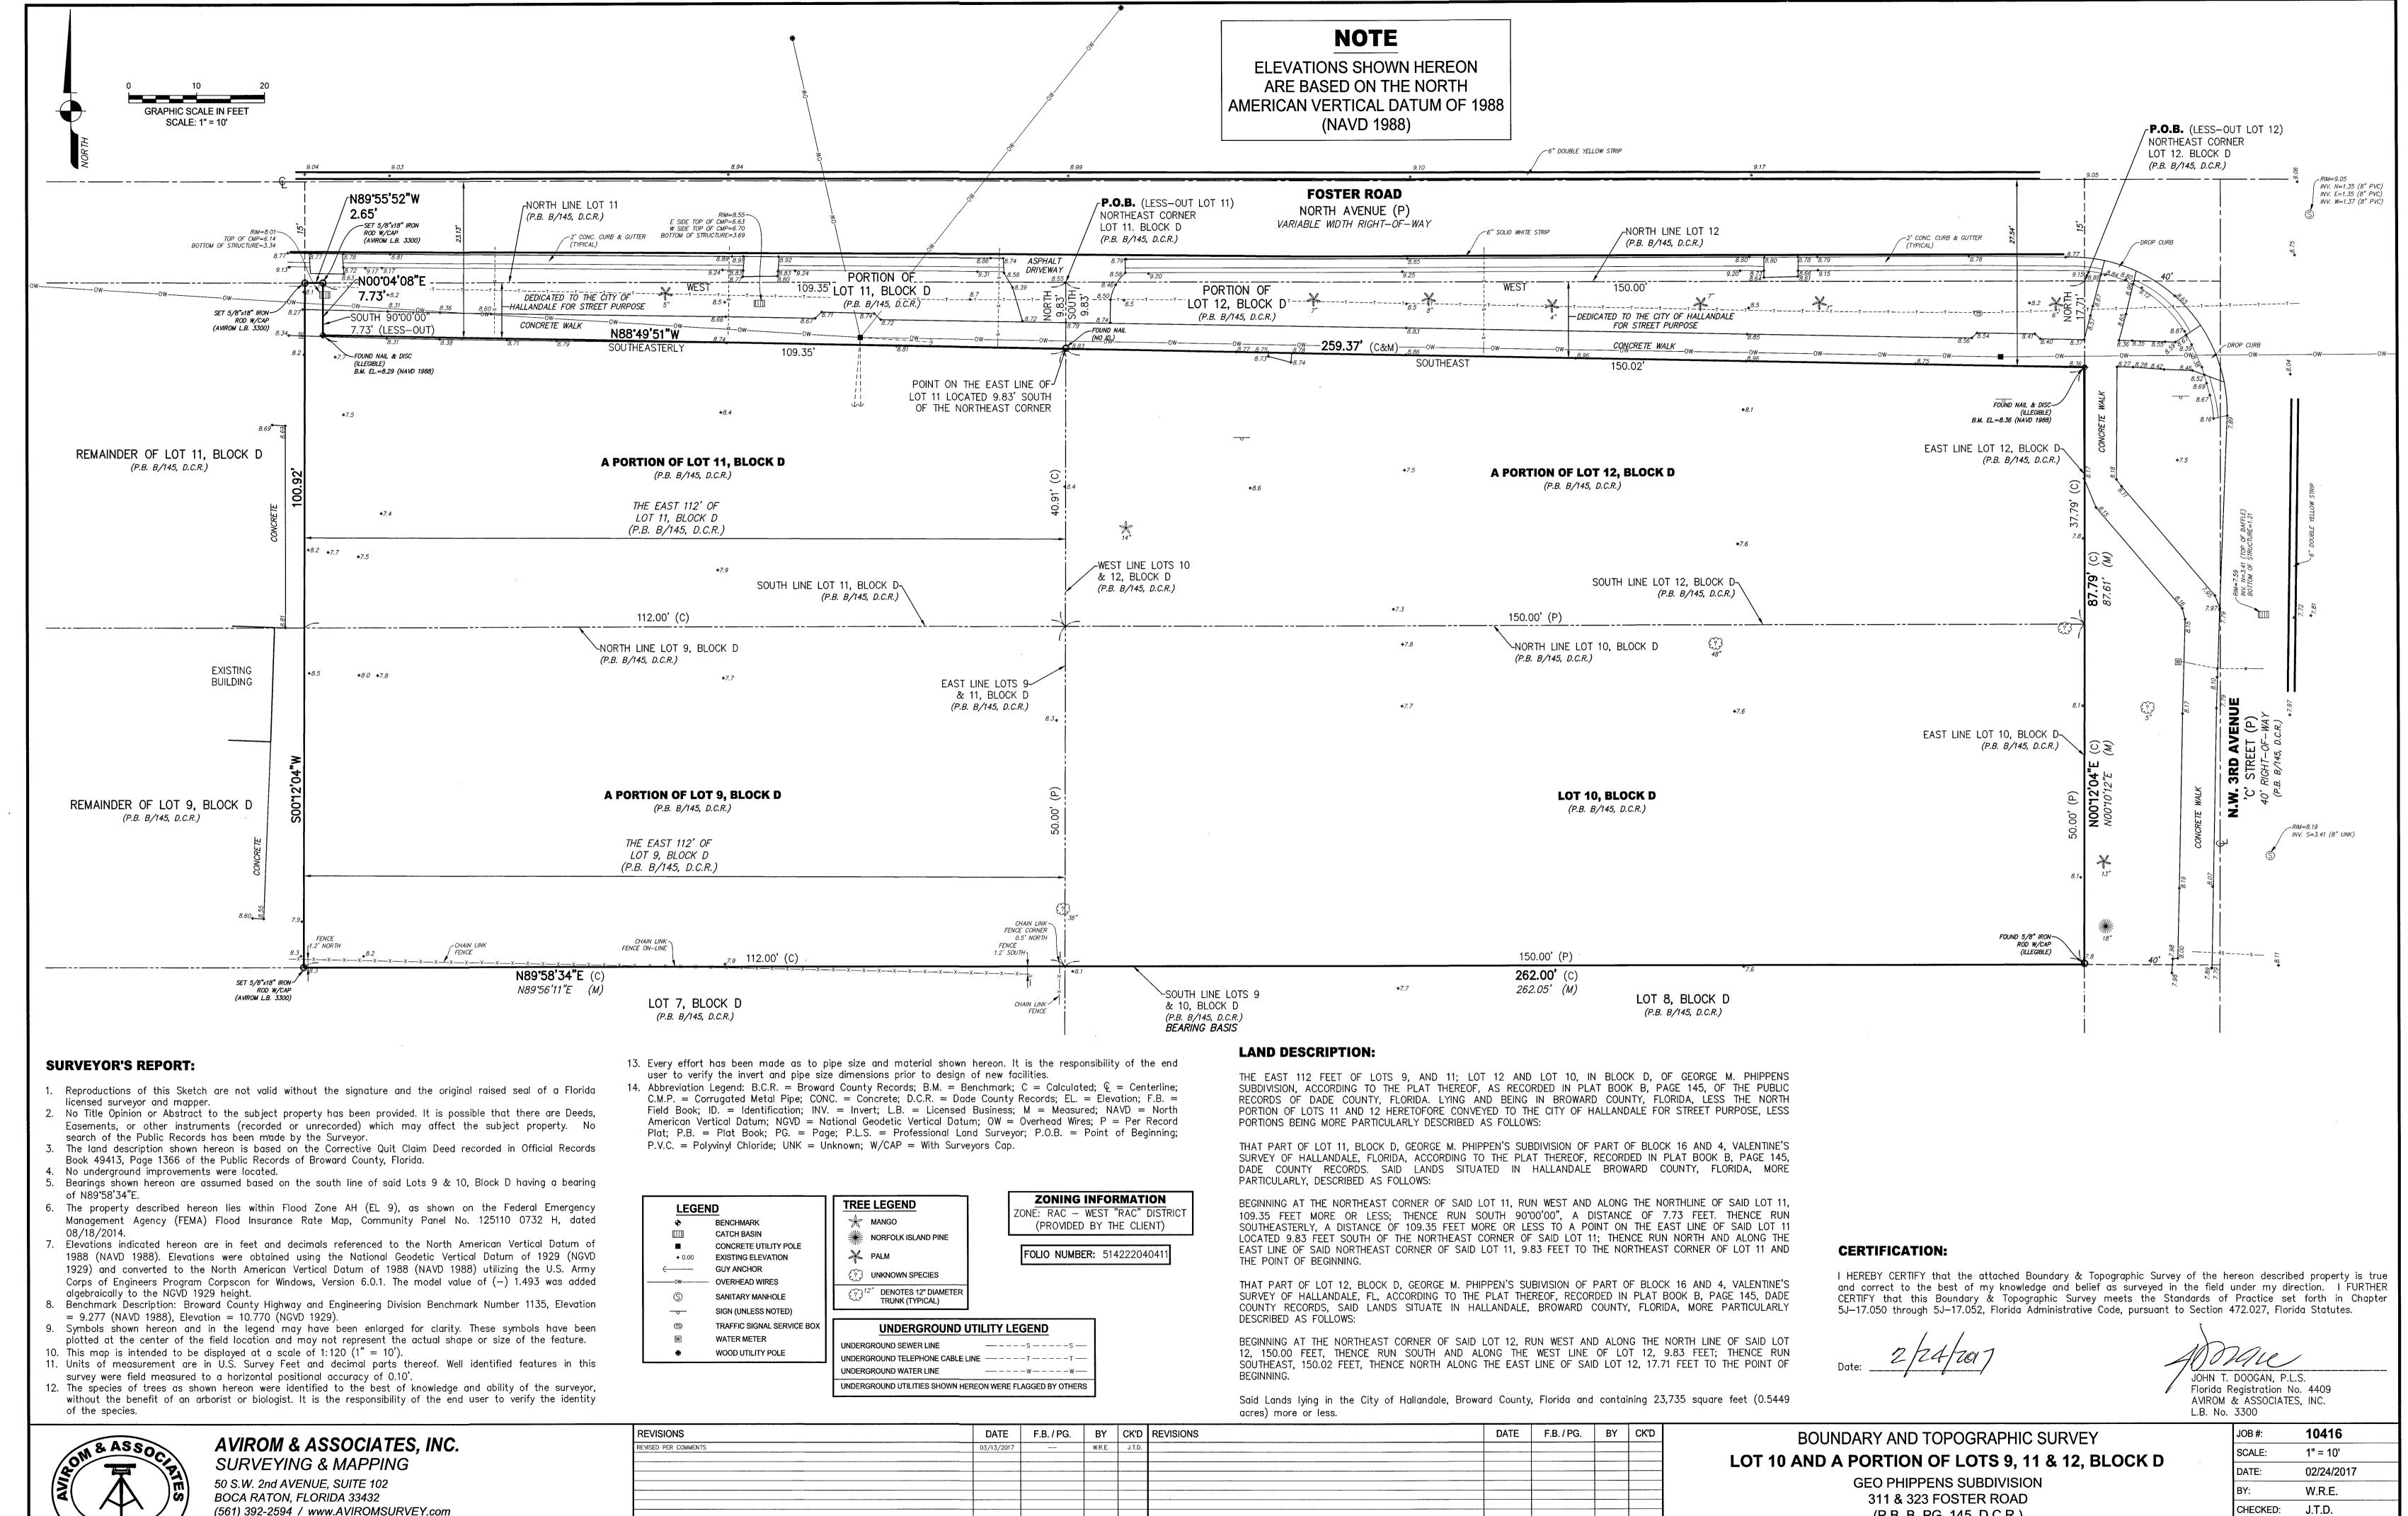


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(P.B. B, PG. 145, D.C.R.) CITY OF HALLANDALE **BROWARD COUNTY, FLORIDA** 

JOR #:		10416	
SCALE:		1" = 10'	
DATE:		02/24/20	17
BY:		W.R.E.	
CHECKE	D:	J.T.D.	
F.B.	1844	PG.	12-16
SHEET:		1 OF	1





**BUILDING #1** 

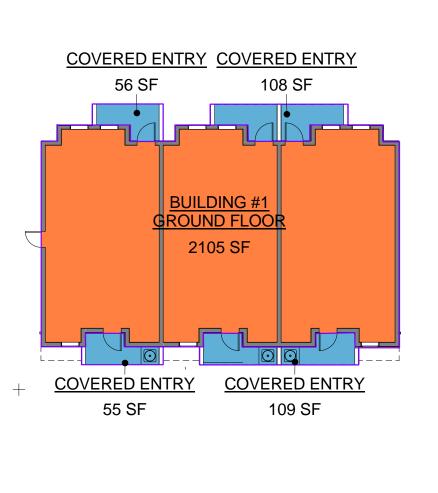
ECOND FLOOI

2192 SF

**BALCONY** 

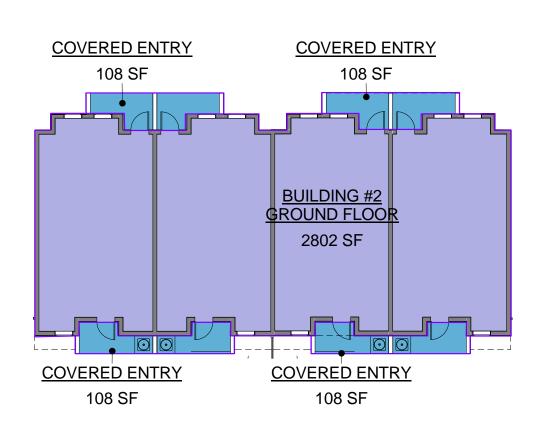


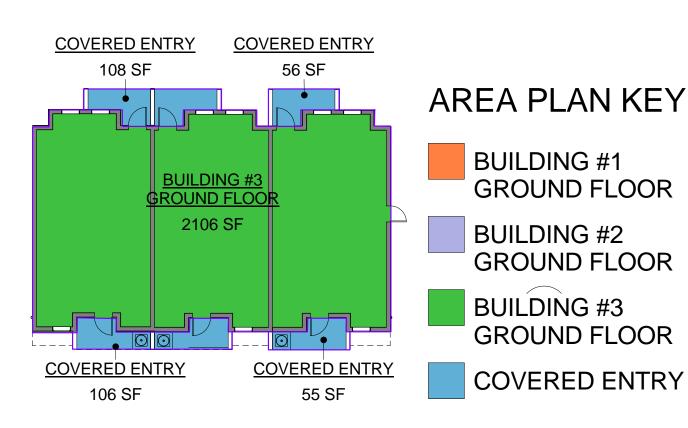

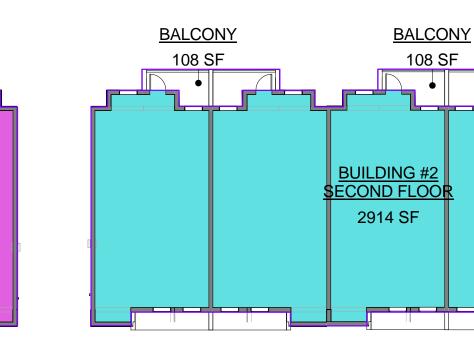

ADJACENT

LUNIT

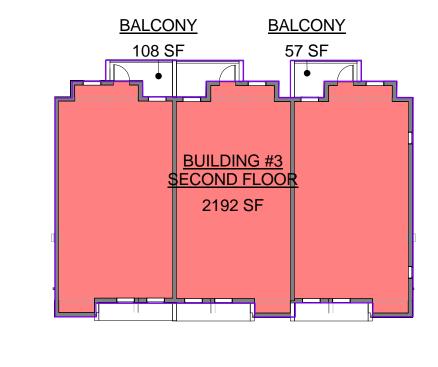

AREA PLAN KEY
BALCONY
BUILDING #1 SECOND FLOOR
BUILDING #2 SECOND FLOOR
BUILDING #3

C BUILDING AREA PLAN AC-1.00 1/16" = 1'-0"

ADJACENT


THALL

## AREA PLAN KEY

SECOND FLOOR

COVERED ENTRY

GROUND FLOOR

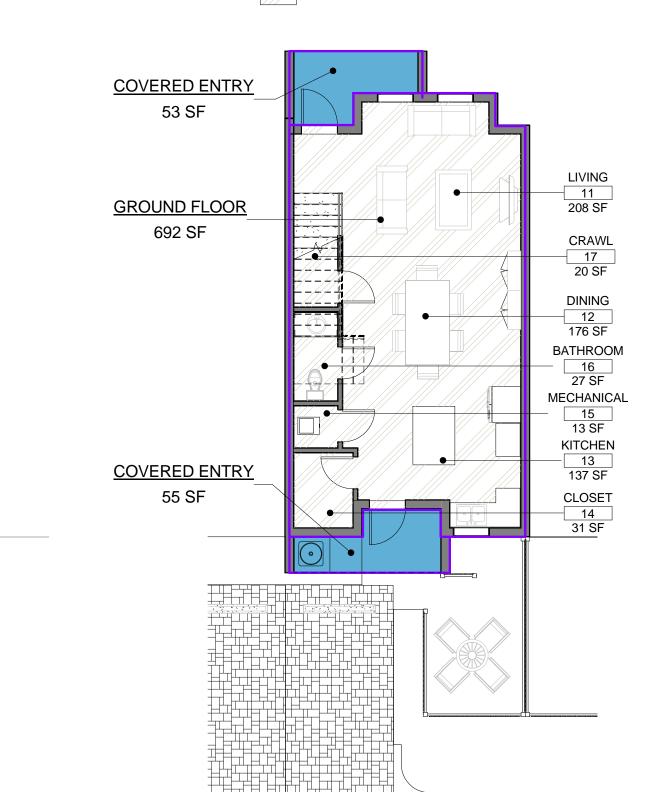



NOTES:

1. TOTAL FLOOR AREA TO ECLUDE BALCONIES AND COCERED ENTRIES

2. NET AREAS APPLY TO UNIT TYPE A & UNIT TYPE B. GROSS AREAS MAY VARY

FLORIDA FIRE PREVENT	ION CODE, 5TH	EDITION	
NFPA 101. LIFE SAFETY (			
OCCUPANCY CLASS	IFICATION		
(CHAPTER 6)	IIIOATION		
		RESIDENTIAL TOTAL	1,578 S.F.
DECLUBED OF DATION OF OOO	U IDANIOIEO	TOTAL	1,578 S.F.
REQUIRED SEPARATION OF OCC 6.1.14.4.1(a) &(b)	SUPANCIES (TABLE		
	R TO R	N/A	N/A
MEANS OF EGRESS	(CHAPTER 7)		
		ALLOWABLE	PROVIDED
OCCUPANT LOAD (TABLE 7.3.1.2)			
RESIDENTIAL 1,578 SF / 20	00 SF	7.88	
TOTAL OCCUPA	ANT LOAD	7.88	8
REQUIRED MEANS OF EGRESS	( CHAPTERS 12-42)		
MINIMUM STAIR WIDTH (TABLE 7	7.2.2.2.1)	36 IN	38 IN
MINIMUM WIDTH PER OCCUPAN SERVED	T (SECTION 7.3.4)		
PER LEVEL	0.2 X 8 = 1.6 IN.	1.6 IN.	36 IN.
NUMBER OF MEANS OF EGRE	ESS (SECTION 7.4)	2	2
ARRANGEMENT OF MEANS O	FEGRESS (SECTION 7.5)	-	* SEE PLAN
1. FIGURE A.7.5.1.3.2 (a) thru FIGUR	E A.7.5.1.3.2 (e)		
DEAD END (TABLE A.7.6)			
	RESIDENTIAL	NO REQ.	N/A
COMMON PATH (TABLE A.7.6)			
	RESIDENTIAL	NO REQ.	57' - 9"

#### ADEA CALCUL ATIONS

AREA (TYPICAL UNIT)	ENCLOSED (SF)	COVERED (SF)	TOTAL (SF)
TYPICAL UNIT GROUND FLOOR	692 SF	108 SF	800 SF
TYPICAL UNIT SECOND FLOOR	723 SF	55 SF	778 SF
TYPICAL UNIT TOTAL	1,415 SF	163 SF	1,578 SF
AREA (BUILDING)	ENCLOSED (SF)	COVERED (SF)	TOTAL (SF
BUILDING 1 GROUND FLOOR	2,105 SF	328 SF	2,433 SF
BUILDING 1 SECOND FLOOR	2,192 SF	165 SF	2,357 SI
BUILDING 1 TOTAL	4,297 SF	493 SF	4,790 SI
BUILDING 2 GROUND FLOOR	2,802 SF	432 SF	3,234 SI
BUILDING 2 SECOND FLOOR	2,914 SF	216 SF	3,130 SF
BUILDING 2 TOTAL	5,716 SF	648 SF	6,364 SF
BUILDING 3 GROUND FLOOR	2,105 SF	328 SF	2,433 SI
BUILDING 3 SECOND FLOOR	2,192 SF	165 SF	2,357 SI
BUILDING 3 TOTAL	4,297 SF	493 SF	4,790 SI
TOTAL PROJECT	14,310 SF	1,634 SF	15,944 SI

#### AREA PLAN KEY

15,944 SF

BALCONY

SECOND FLOOR

## LIFE SAFETY LEGEND

\*OLF = OCCUPANT LOAD FACTOR

**BUILDING DATA:** 

MAX. NO. STORIES

AREA: ONE STORY

OCCUPANCY CLASSIFICATION (CHAPTER 3)

TYPE OF CONSTRUCTION (CHAPTER 6)

MAXIMUM HEIGHT IN FEET (TABLE 503, SECTION 504)

AREA: MULTISTORY (CHAPTER 5, TABLE 503, SEC. 506, 507.2)

\* PER SECTION 706.4.1.2, WHEN NOT MORE THAN THREE STORIES IN HEIGHT TOWNHOUSES MAY BE SEPERATED BY A SINGLE WALL. SUCH WALL SHALL PROVIDE NOT LESS THAN 2 HOUR FIRE RESISTANCE

EXTERIOR (TABLE 602)

NONBEARING WALLS AND PARTITIONS

AND SECONDARY MEMBERS

AND SECONDARY MEMBERS

PRIMARY STRUCTURAL FRAME

INTERIOR

INTERIOR

FLOOR CONSTRUCTION

ROOF CONSTRUCTION

FIRE SEPARATION DISTANCE

0 FT TO 5 FT

OVER 30 FT

TOTAL OCCUPANT LOAD

OVER 5 FT TO 10 FT

OVER 10 FT TO 30 FT

MEANS OF EGRESS (CHAPTER 10)

OCCUPANT LOAD (SECTION 1004, TABLE 1004.1.1)

RESID (R-2) - (1/200 GROSS, 1,445/200 = 7.23)

STAIRS (0.3 X 7.23 (2ND FL) = 2.17)

MINIMUM CLEAR OPENING OF EXIT DOORS (SECTION

EGRESS WIDTH PER OCCUPANT SERVED

LEVEL (0.2 X 7.23 = 1.45)

MINIMUM STAIR WIDTH (SECTION 1009.1)

DEAD ENDS (SECTION 1018.4)

COMMON PATH OF EGRESS (SECTION 1014.3)

MININUM NUMBER OF EXITS (TABLE 1021.1)

EXIT ACCESS TRAVEL DISTANCE (TABLE 1016.1)

BEARING WALLS

FLORIDA BUILDING CODE 2014 5TH EDITION

REQUIRED SEPARATION OF OCCUPANCIES (SECTION 706) R-2 TO R-2

FIRE RESISTANCE RATINGS FOR BUILDING ELEMENTS- (TABLE 601)

FIRE RESISTANCE RATINGS FOR EXTERIOR WALLS- (TABLE 602)

INCLUDING COLUMNS, GIRDERS, TRUSSES 0 HR

R-2 RESIDENTIAL

ALLOWED

40 FT

7,000 SF

3 HR. (2 HR\*)

ALLOWED

0 HR

0 HR

0 HR

0 HR

ALLOWED

ALLOWABLE

7.23

2.17

1.45 IN

32 IN.

36 IN.

1 PER DWELLING UNIT 1 PER DWELLING UNIT NOT REQ. 1 KITCHEN DWELLING UNIT UNIT

 REQUIRED
 PROVIDED
 REQ.
 PRVD.
 REQ.
 PRVD.
 REQ.
 PRVD.
 REQ.
 PRVD.

 1
 1
 0
 1
 1
 1

8 1 3 1 3 0 0 1 1 1 2

PLUMBING FIXTURE CALCULATIONS: TYPICAL UNIT

PER FLORIDA PLUMBING CODE, 5TH EDITION (2014), (TABLE 403.1.) MINIMUM NUMBER OF REQUIRED PLUMBING FIXTURES

OCCUPANCY WATER LAVATORIES DRINKING SERVICE SHOWER

75 FT. (125 FT.\*)

200 FT. (250 FT.\*)

FOUNTAIN SINK

7.23 (8)

N/A

TYPE V (B) (UN-SPRINKLERED)

**BUILDING #1** 

BUILDING #2

**BUILDING #3** 

PROVIDED

SEE AREA CALCULATIONS

PROVIDED

0 HR

0 HR

0 HR

0 HR

0 HR

0 HR

**PROVIDED** 

PROVIDED

36 IN

34 IN

34 IN

36 IN

57'-9"

40'-10"

N/A

+/- 27'-0"

N/A

----- COMMON PATH

⟨FE⟩ FIRE EXTINGUISHER - MP5 (OR APPROVED EQUAL)

MALE/FEMALE

GENERAL NOTES:

RESIDENTIAL (R-2)

1,578 SF / 200 7.89

(OLF\* (T1004.1.2) =

1. FIRE EXTINGUISHERS TO BE MULTI-PURPOSE ABC (DRY CHEM) INSTALL IN ACCORDANCE W/ NFPA 10.

FOR THE USE OF THE PLANNING & ZONING DEPARTMENT

MATTHEW F. WEST

AR 93859

ARCHITECTURE + DESIGN, LLC AA26001503

318 SOUTH DIXIE HIGHWAY SUITE 4-5 LAKE WORTH FL 33460 561-588-2027 T 561-582-9419 F

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**CONSULTANT:** 

DESIGN & BUILD FOR:

## **HALLANDALE** COMMONS

301-323 FOSTER RD. HALLANDALE BEACH FL

DATE: 03-16-2017 NUMBER: A16-011 REVIEWED: MANAGED:

**REVISION:** 

DRAWN:

1 04-27-2017 DRC COMMENTS


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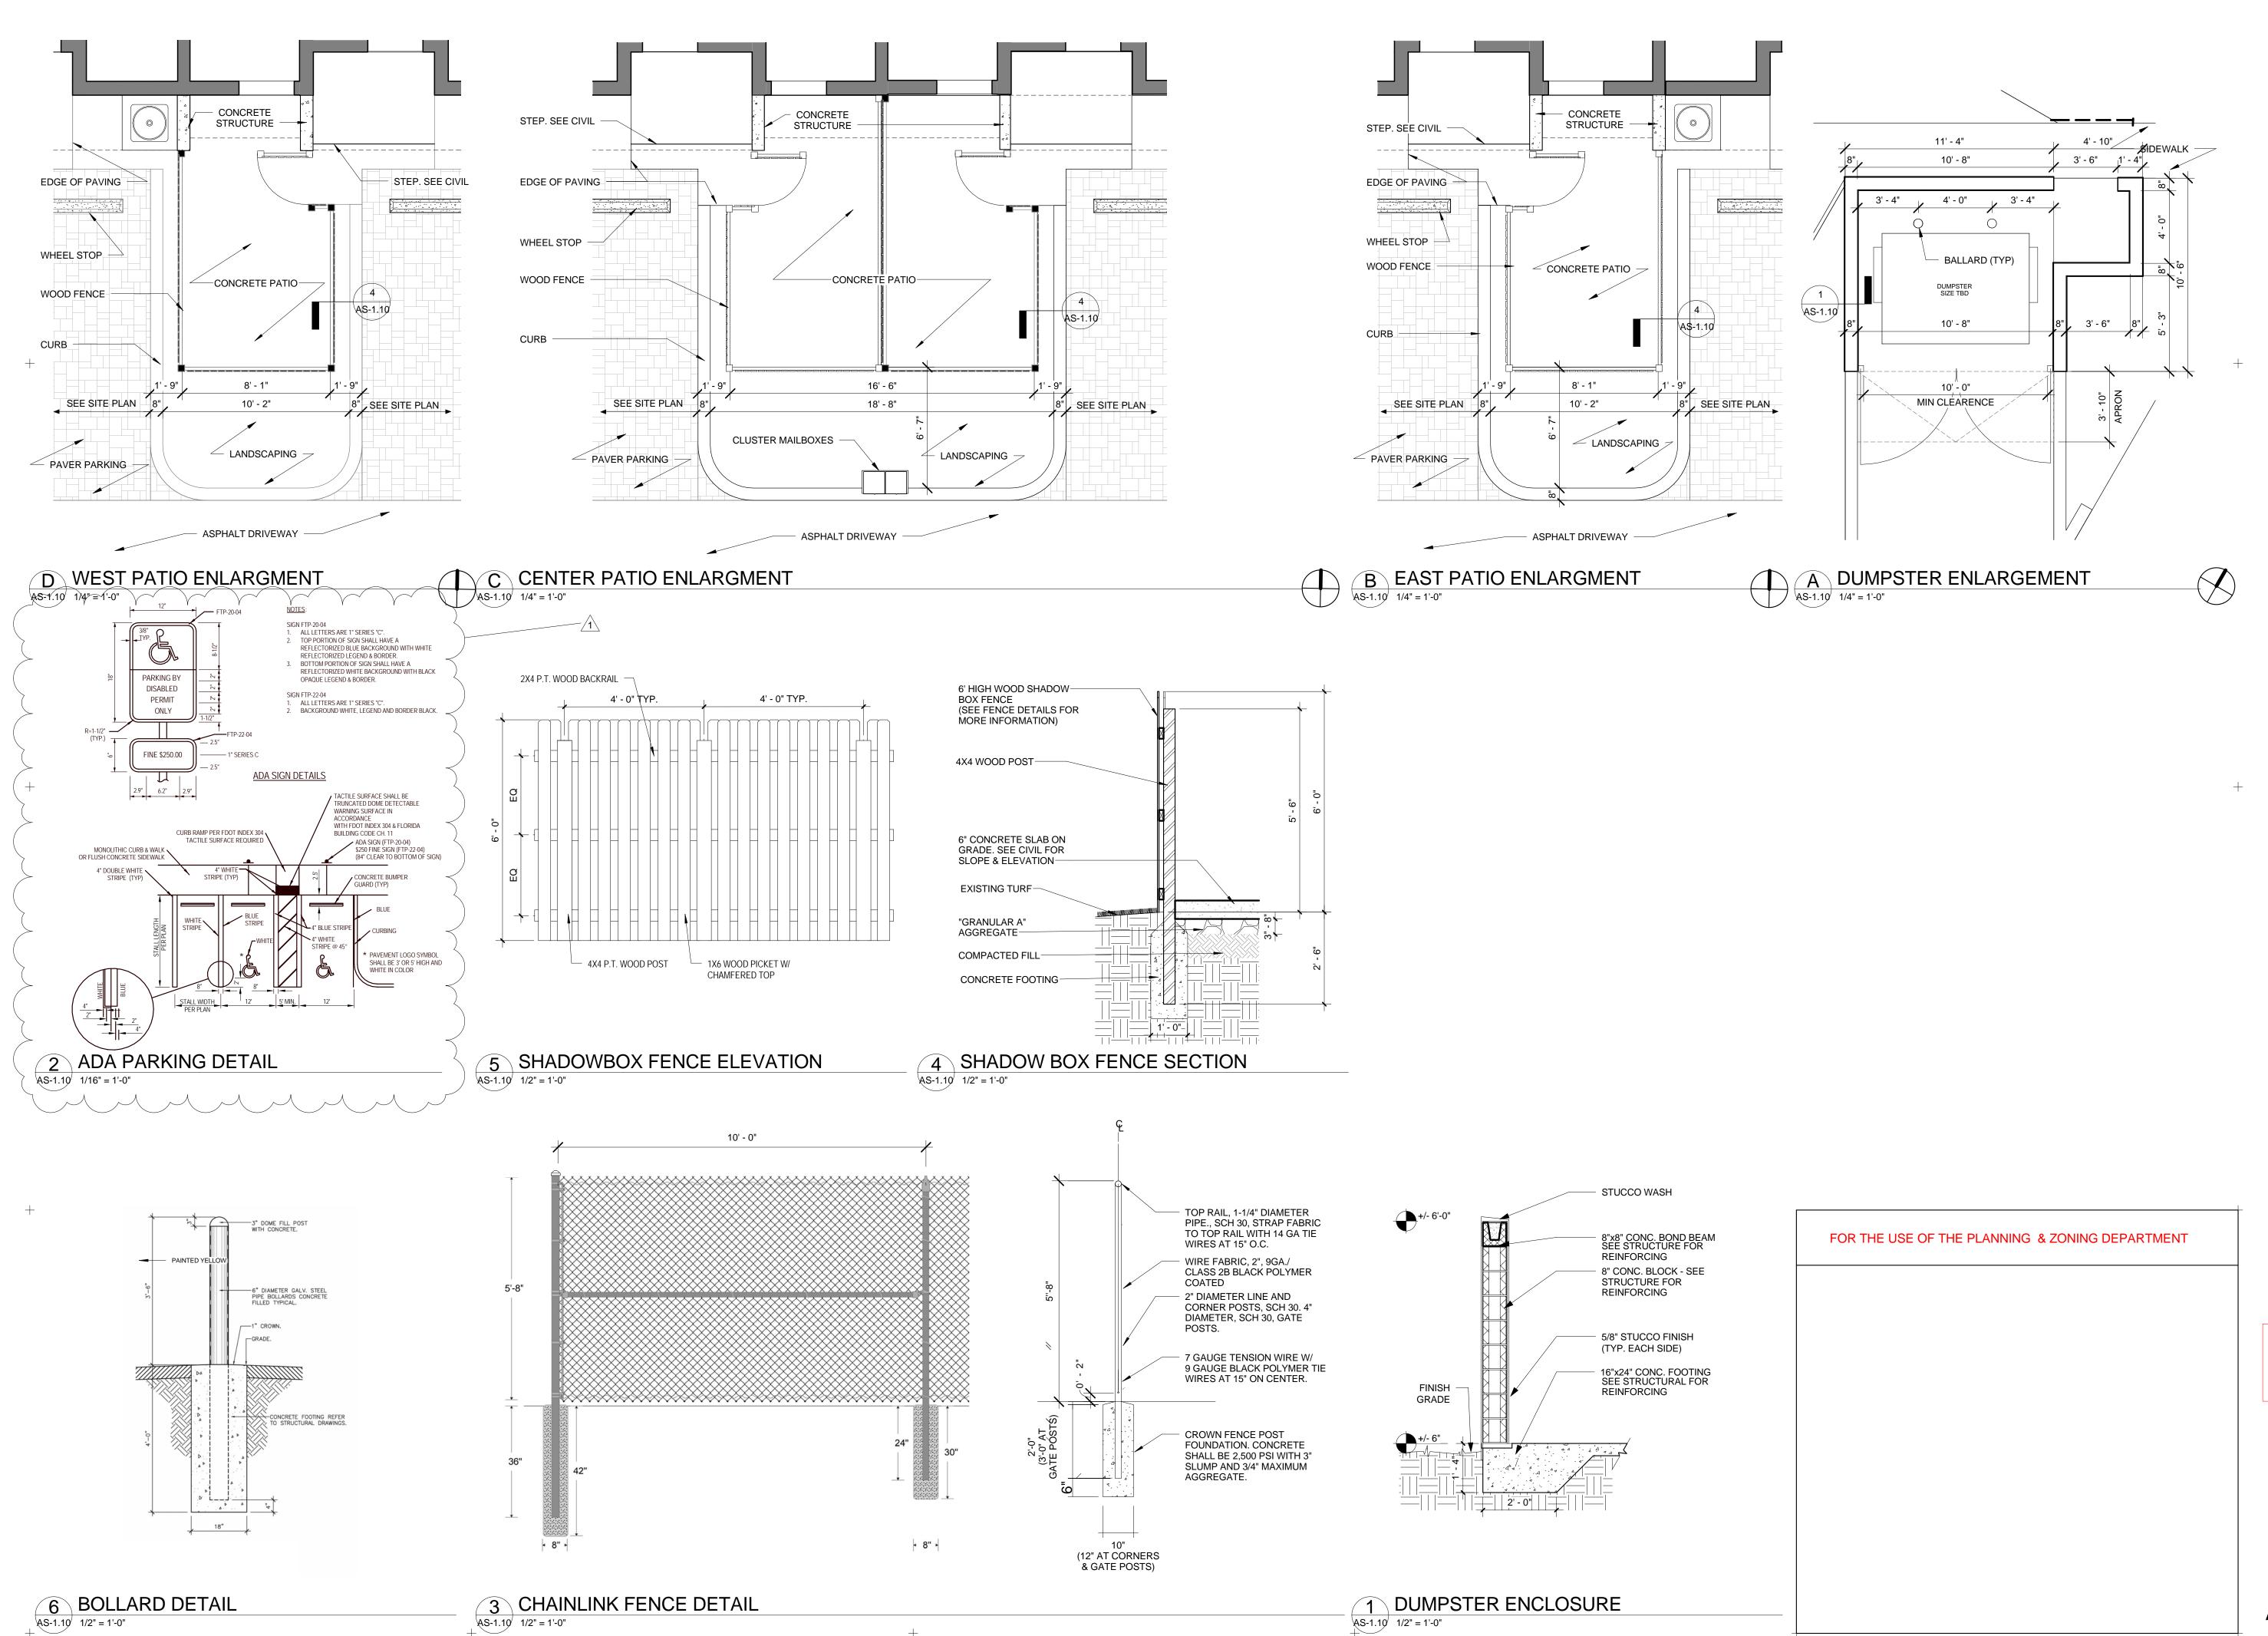
**BUILDING CODE INFORMATION +** LIFE SAFETY PLAN + AREA **CALCULATIONS** 

AC-1.00

B TYPICAL UNIT LIFE SAFETY PLAN AC-1.00 1/8" = 1'-0"

AC-1.00 1/8" = 1'-0"



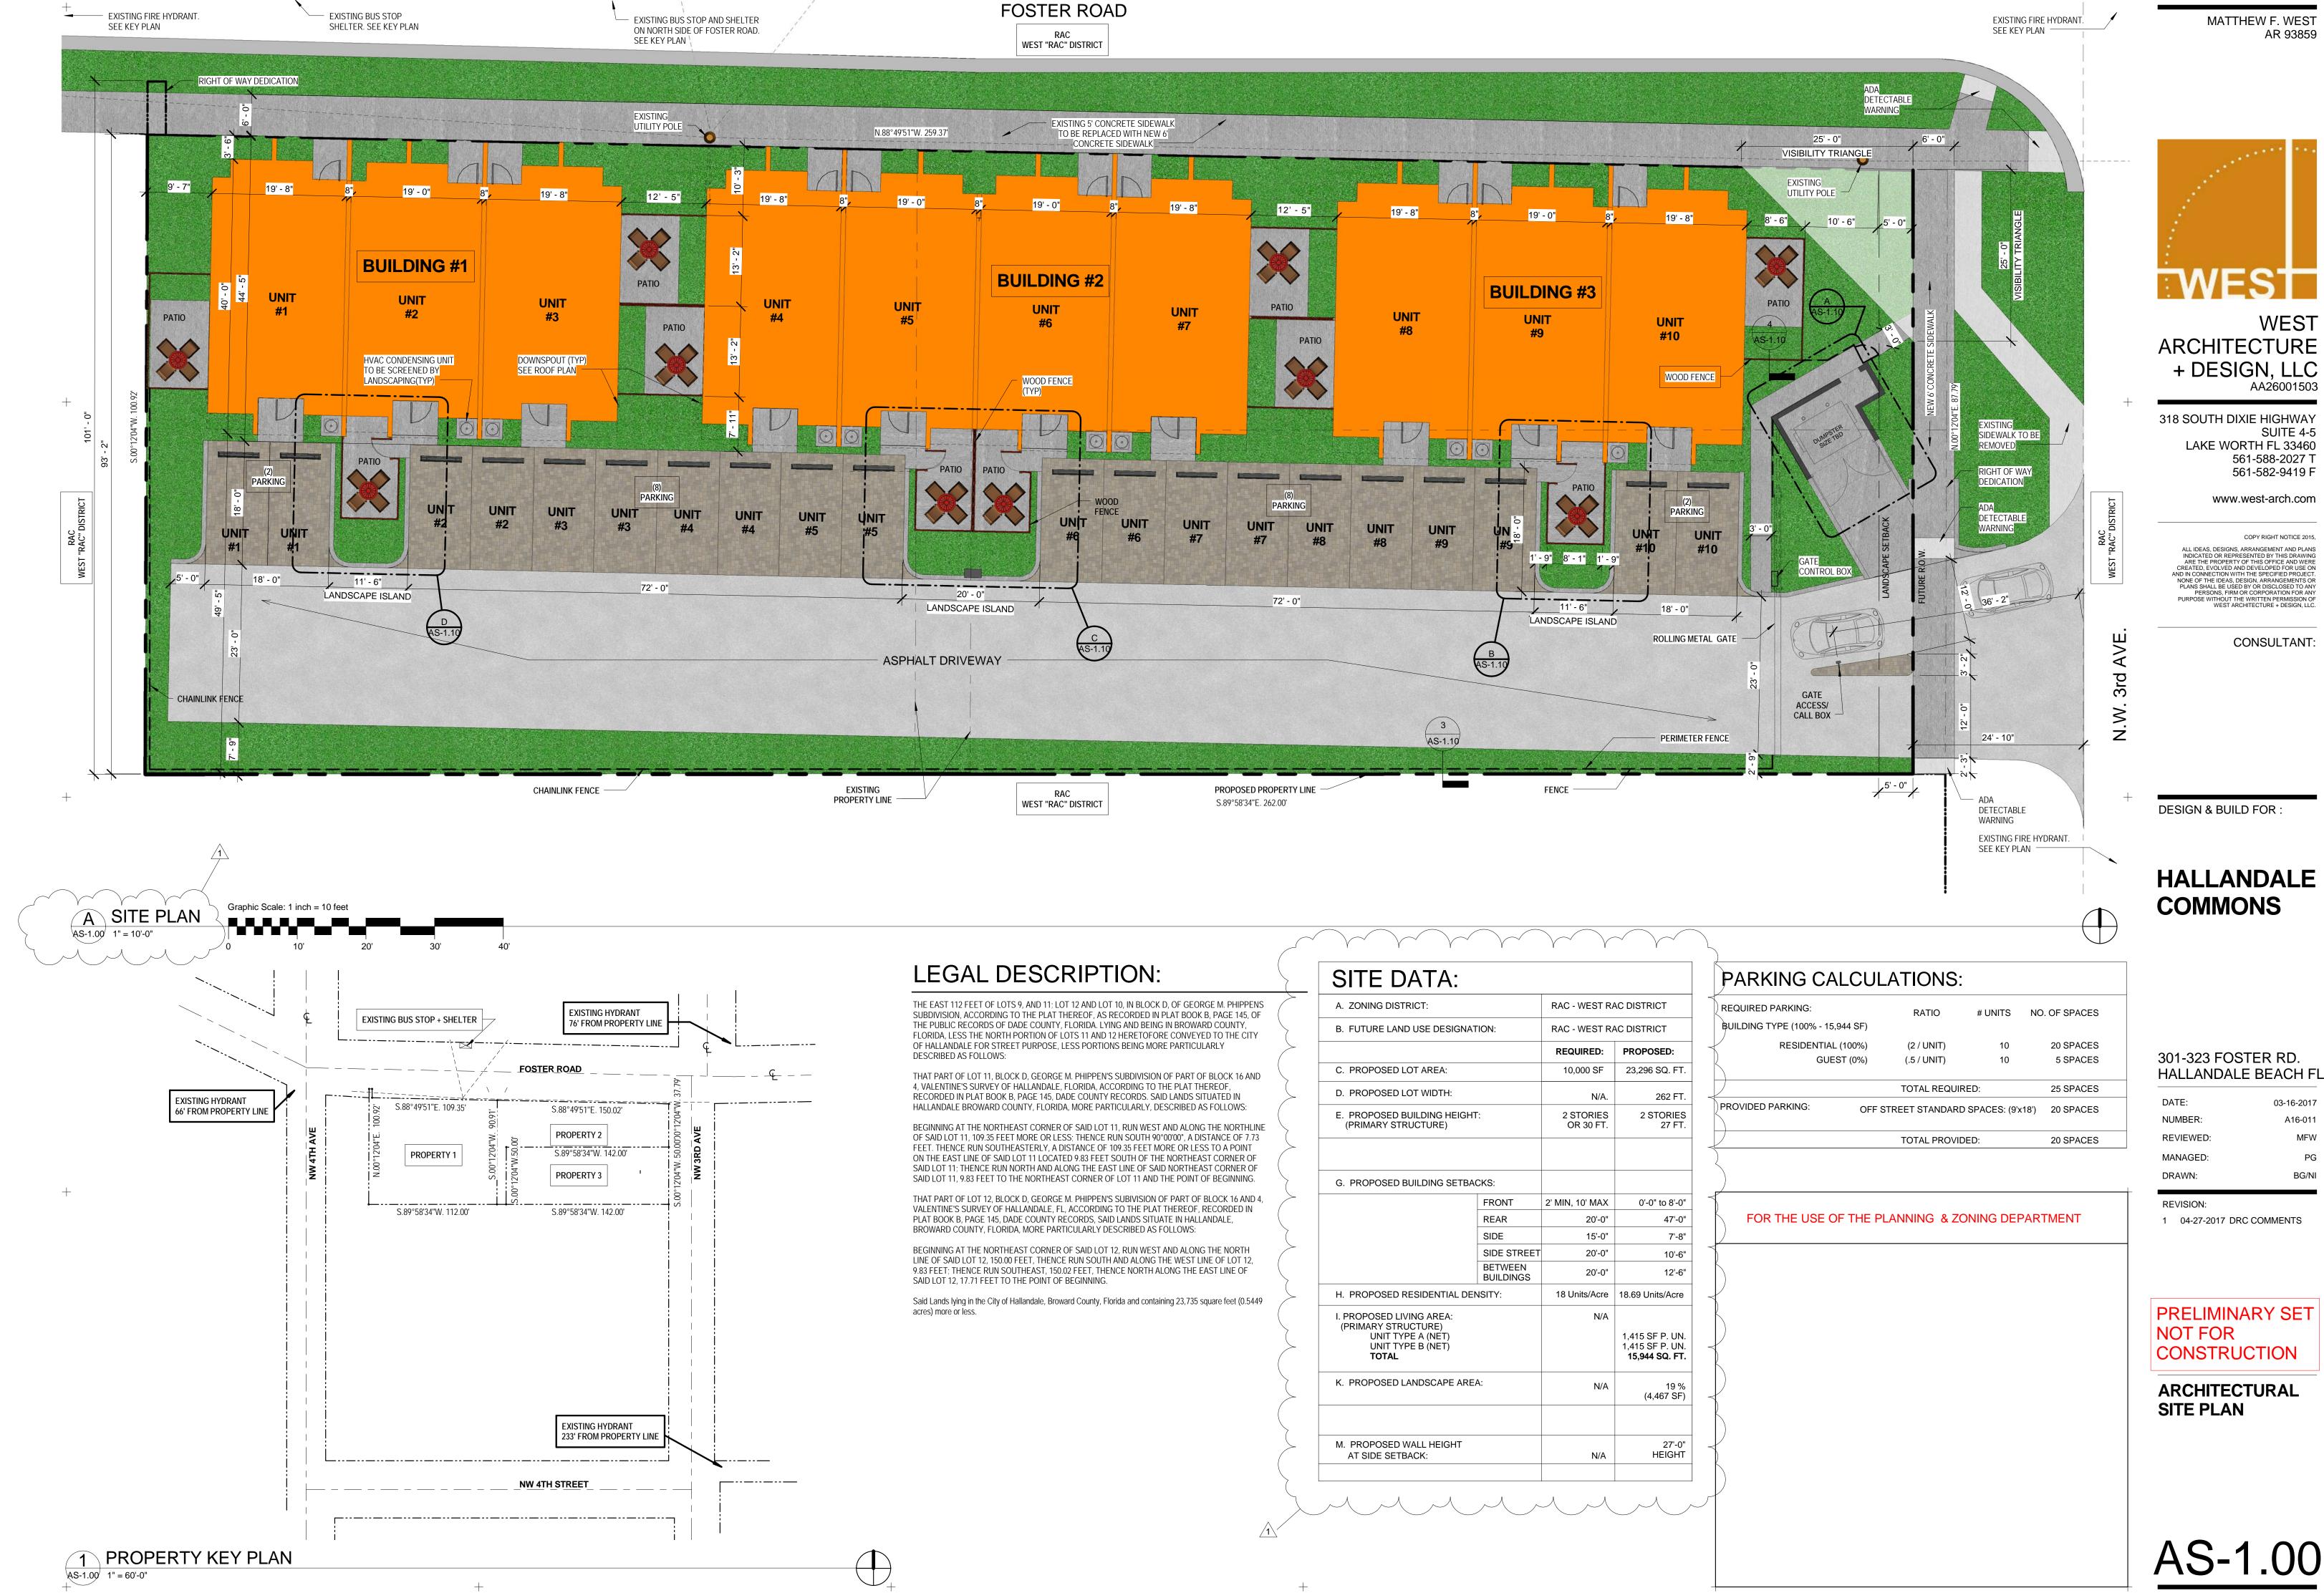

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MANAGED: PG

DRAWN: NI

REVISION:

1 04-27-2017 DRC COMMENTS

PRELIMINARY SET NOT FOR CONSTRUCTION

ARCHITECTURAL SITE PLAN DETAILS

AS-1.10



+ DESIGN, LLC
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318 SOUTH DIXIE HIGHWAY

561-588-2027 T 561-582-9419 F www.west-arch.com

SUITE 4-5 LAKE WORTH FL 33460

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### HALLANDALE COMMONS

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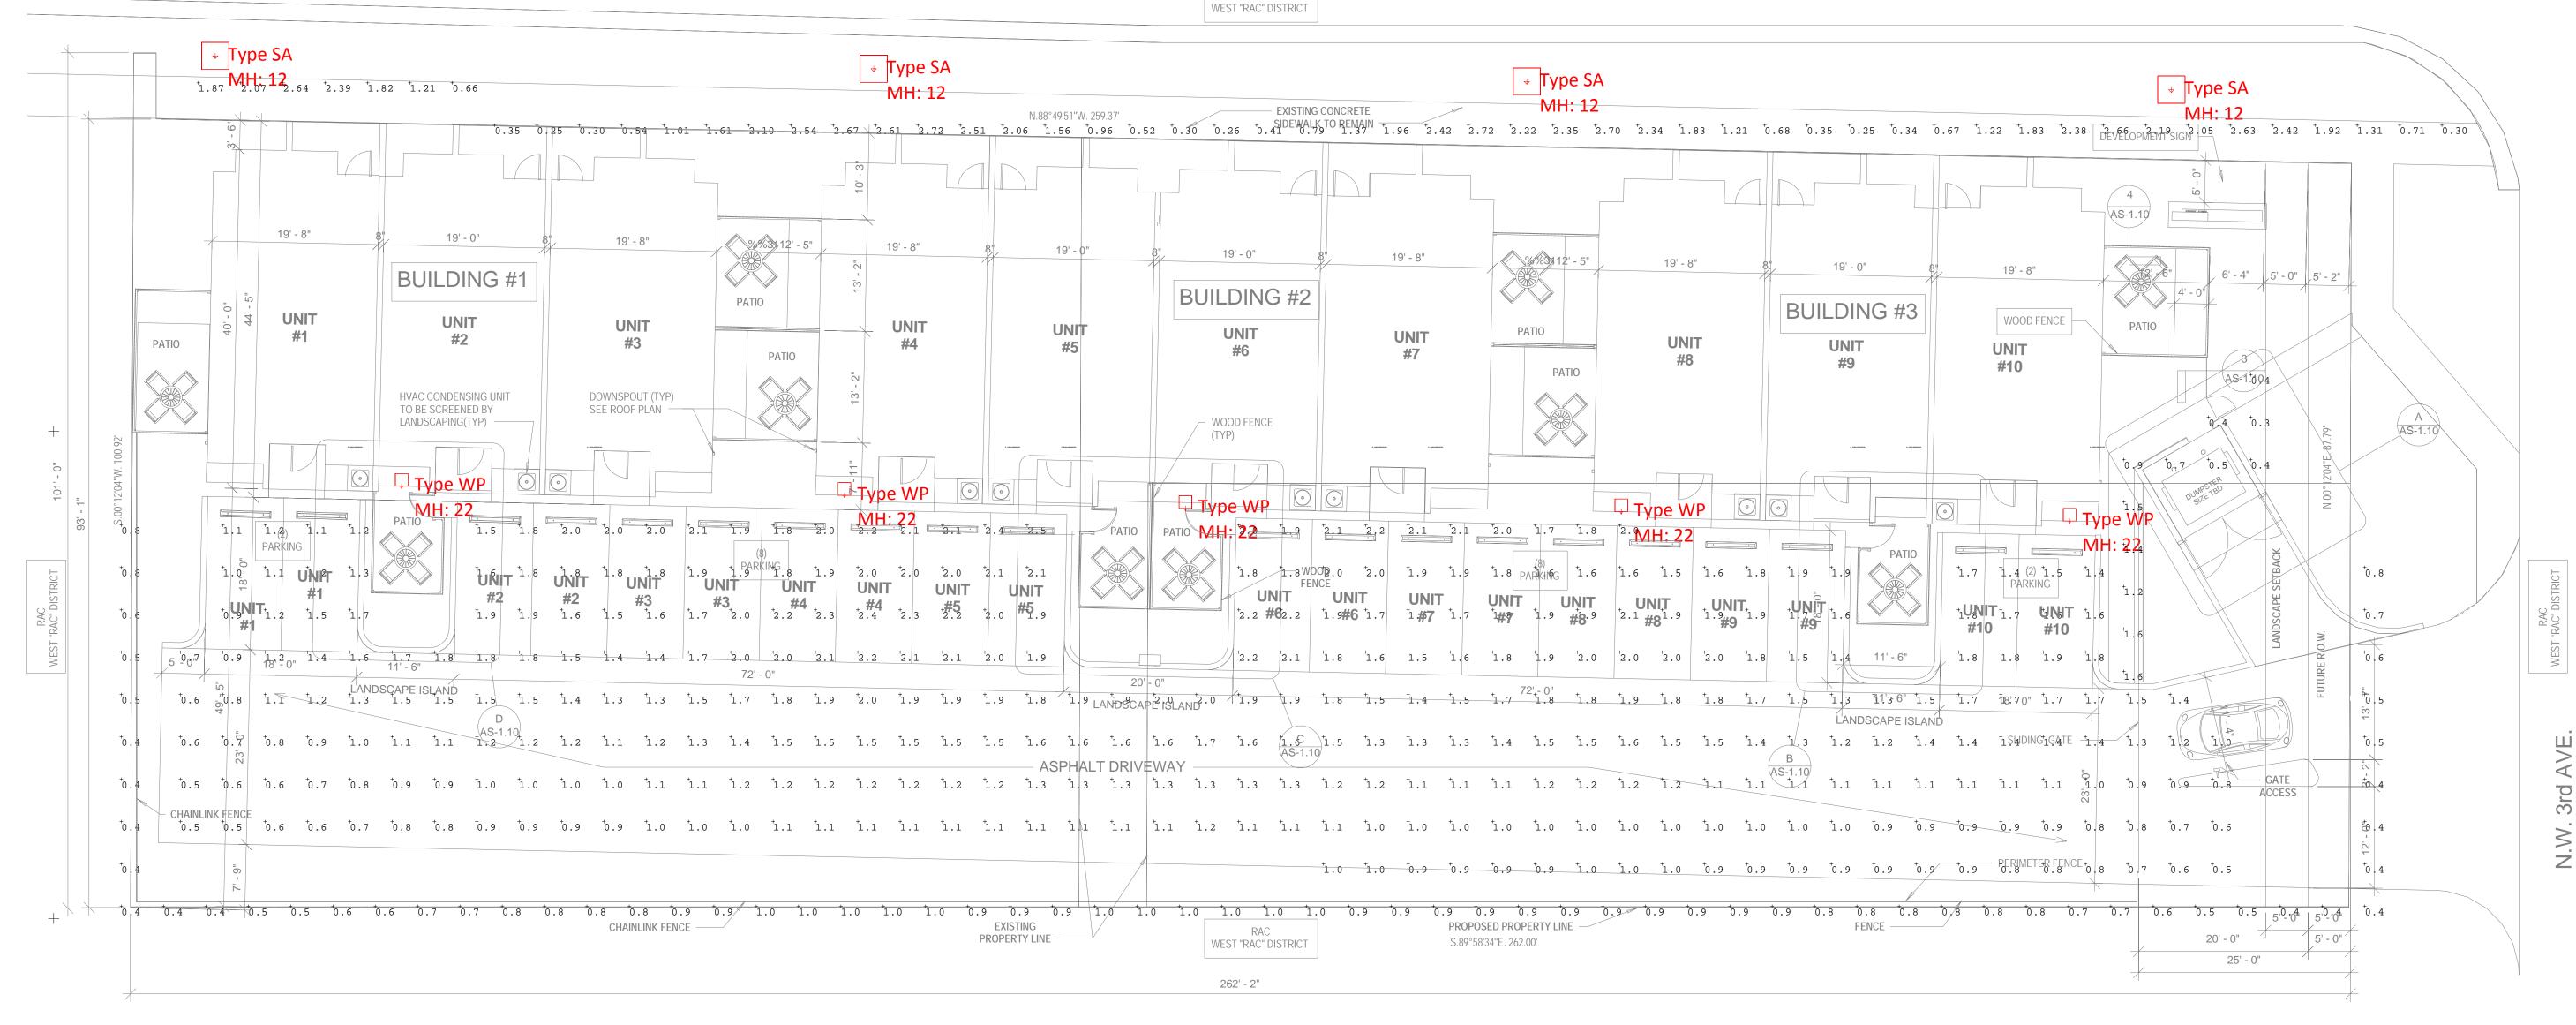
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1 04-27-2017 DRC COMMENTS

Author

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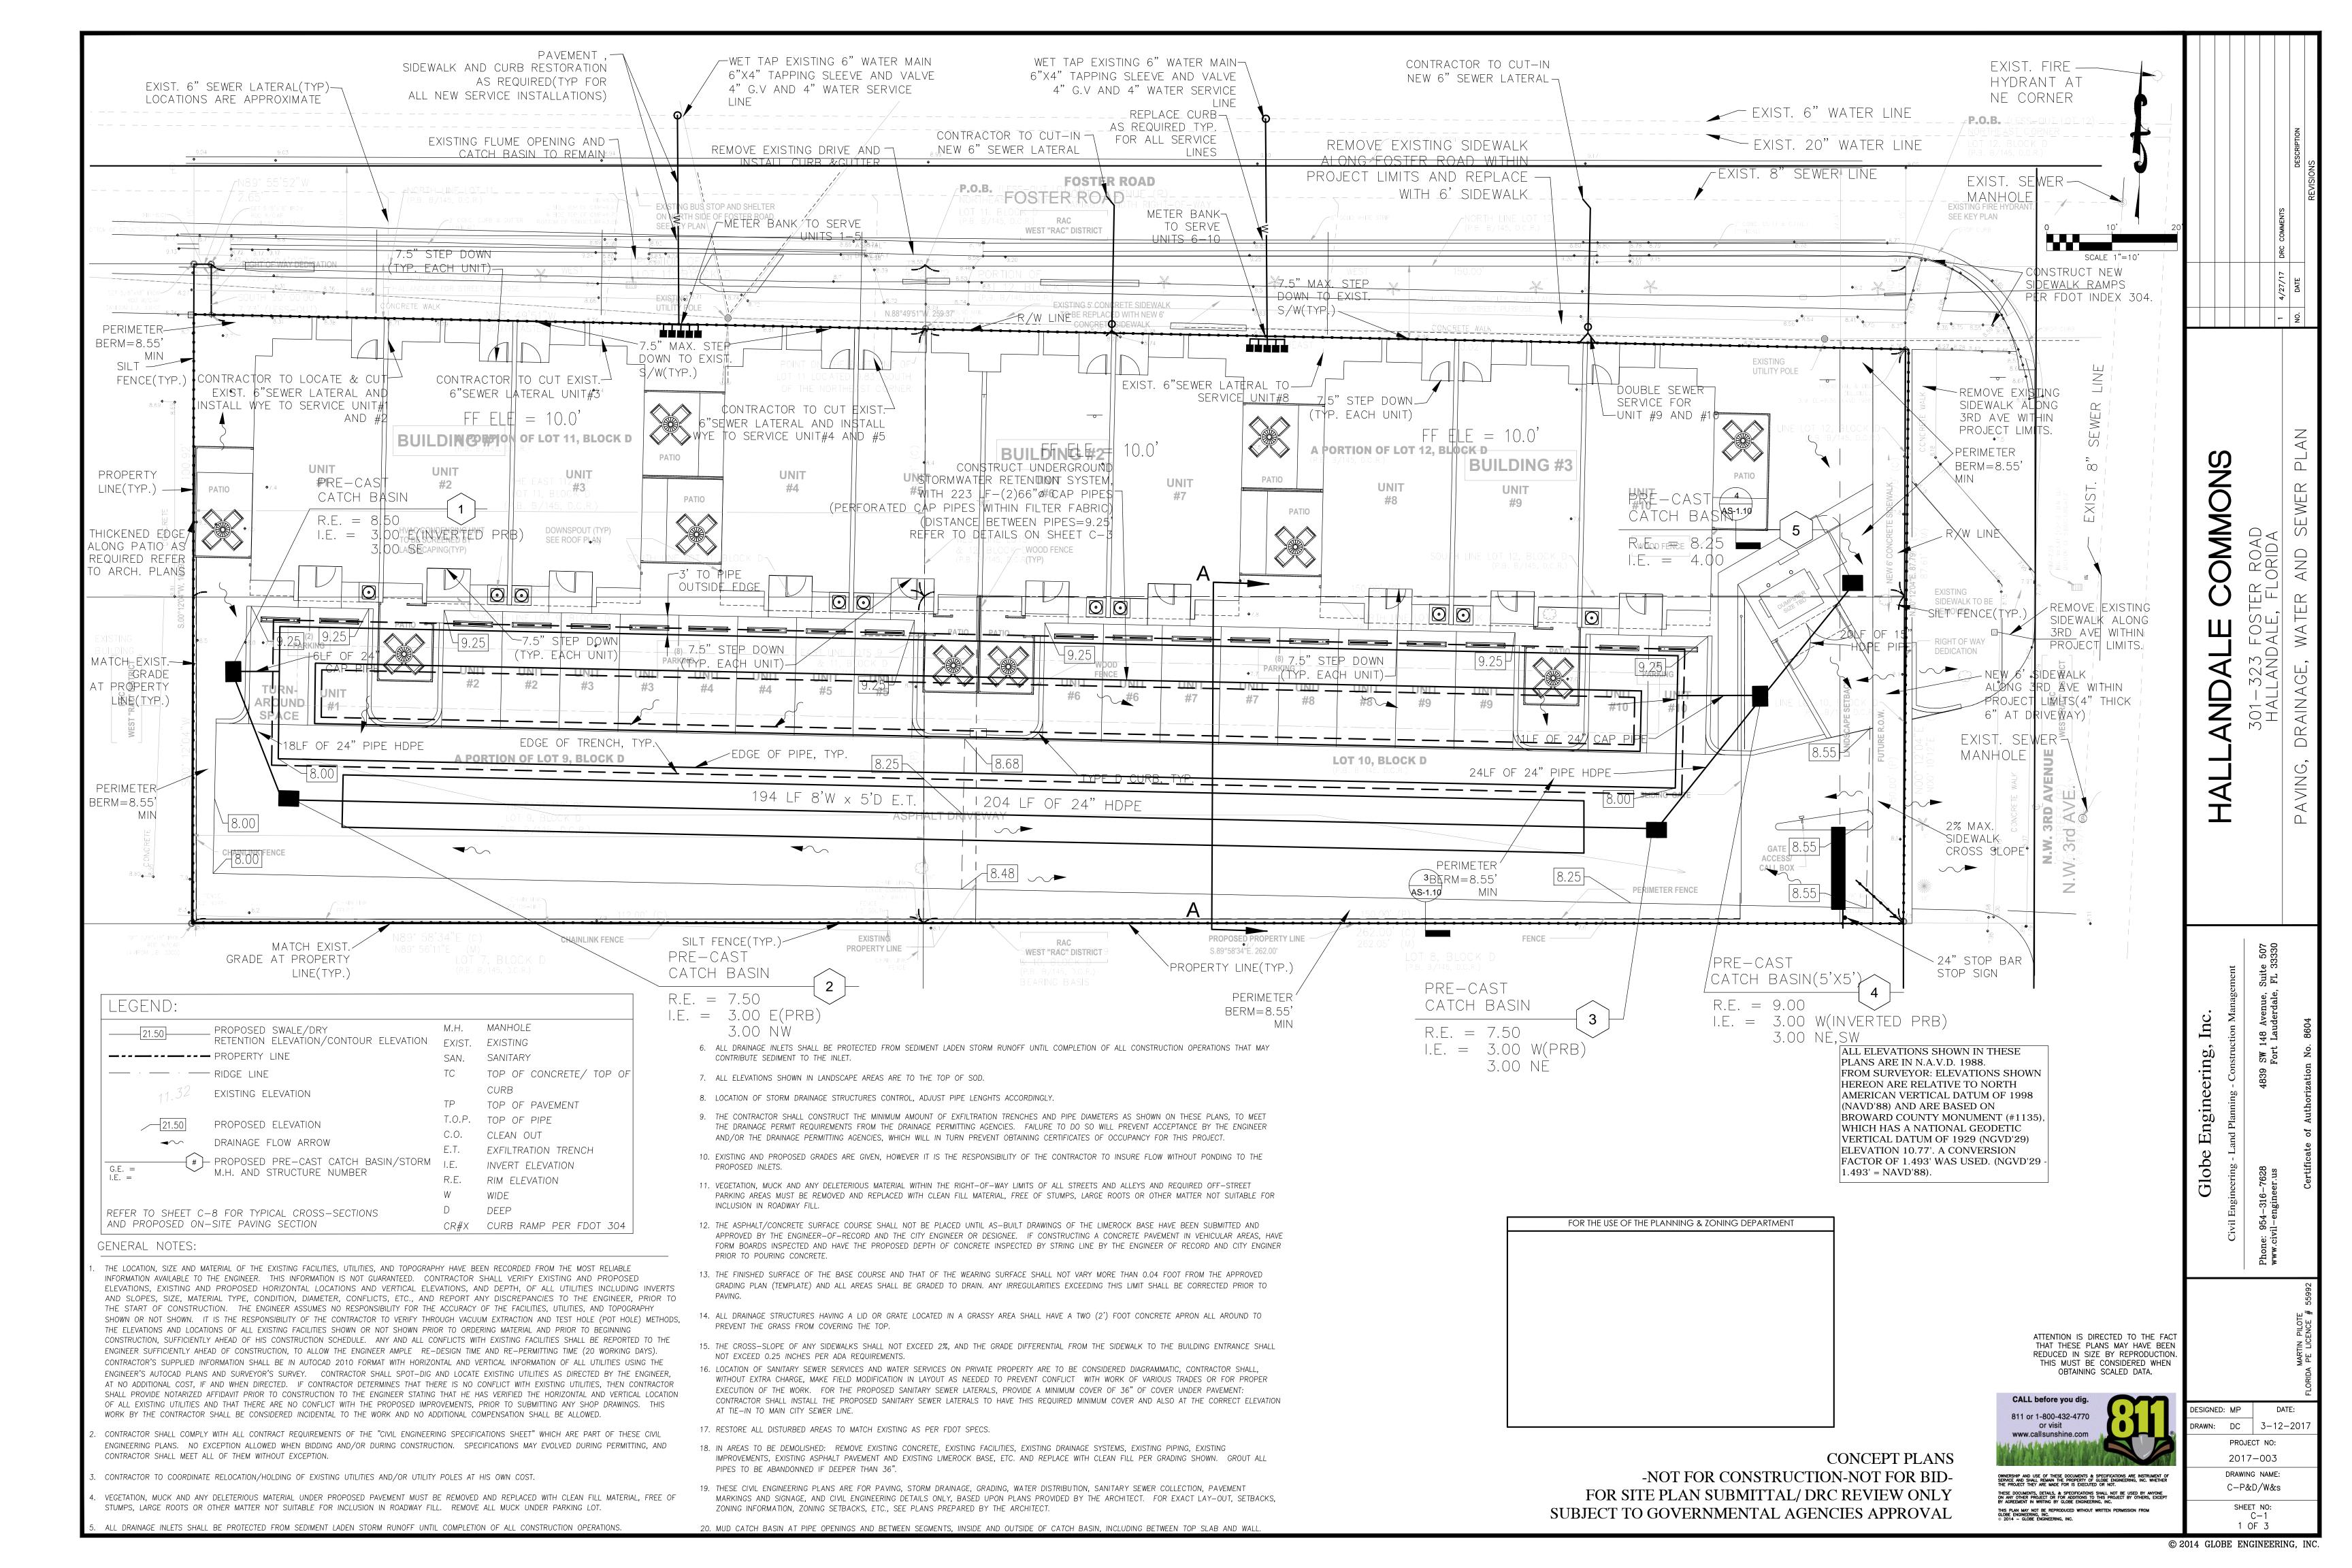
SITE PHOTOMETRICS




Luminaire S	Schedule					
Label	Symbol	Qty	Description	LLF	Lum. Lumens	Lum. Watts
Гуре SA	<b>→</b>	4	LA 4421 70W LED T5 5K	0.900	6010	69.76
Гуре WP	-	5	MCGRAW-EDISON#: GWC-AF-01-LED-E1-T4FT	0.900	6395	59

Calculation Summary							
Label	CalcType	Units	Avg	Max	Min	Avg/Min	Max/Min
East Sidewalk	Illuminance	Fc	0.91	1.6	0.3	3.03	5.33
North Sidewalk	Illuminance	Fc	1.55	2.72	0.25	6.20	10.88
Parking	Illuminance	Fc	1.43	2.5	0.5	2.86	5.00
Propery Line_1	Illuminance	Fc	0.73	1.0	0.4	1.83	2.50

Graphic Scale: 1 inch = 10 feet



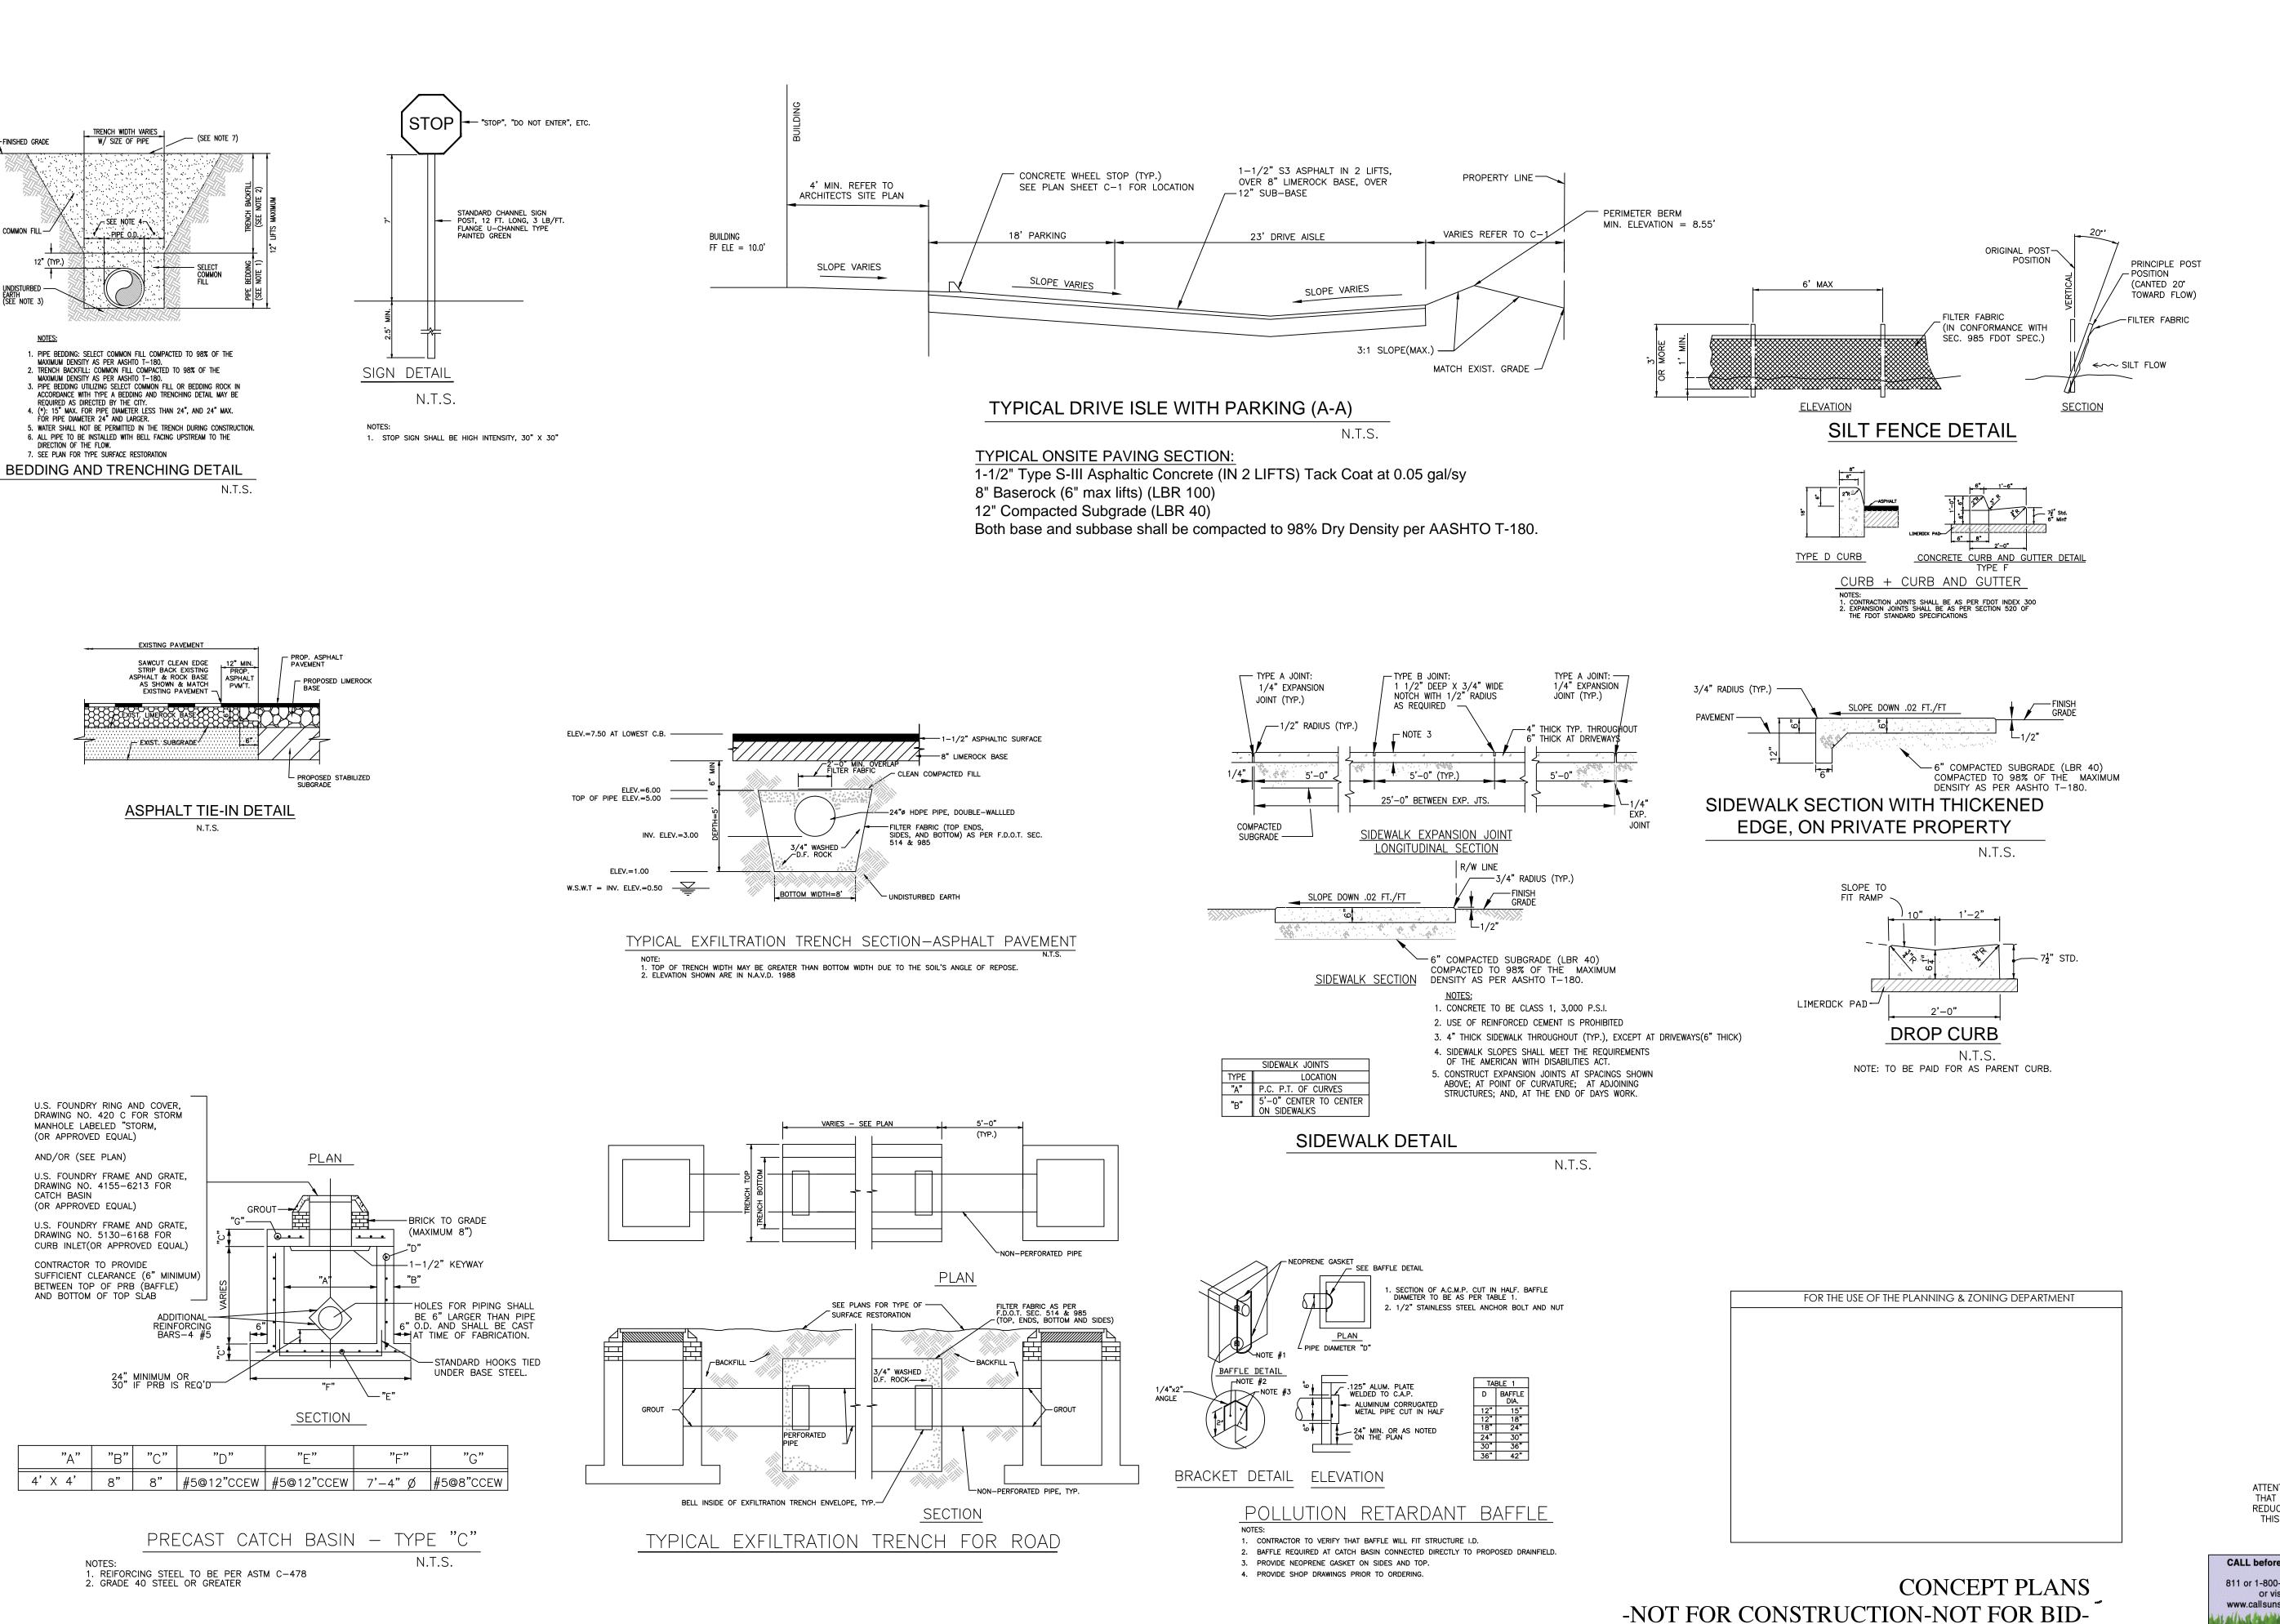

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CALL before you dig. 811 or 1-800-432-4770 or visit www.callsunshine.com

FOR SITE PLAN SUBMITTAL/ DRC REVIEW ONLY

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DRAWING NAME: C-2 SHEET NO: 2 OF 3


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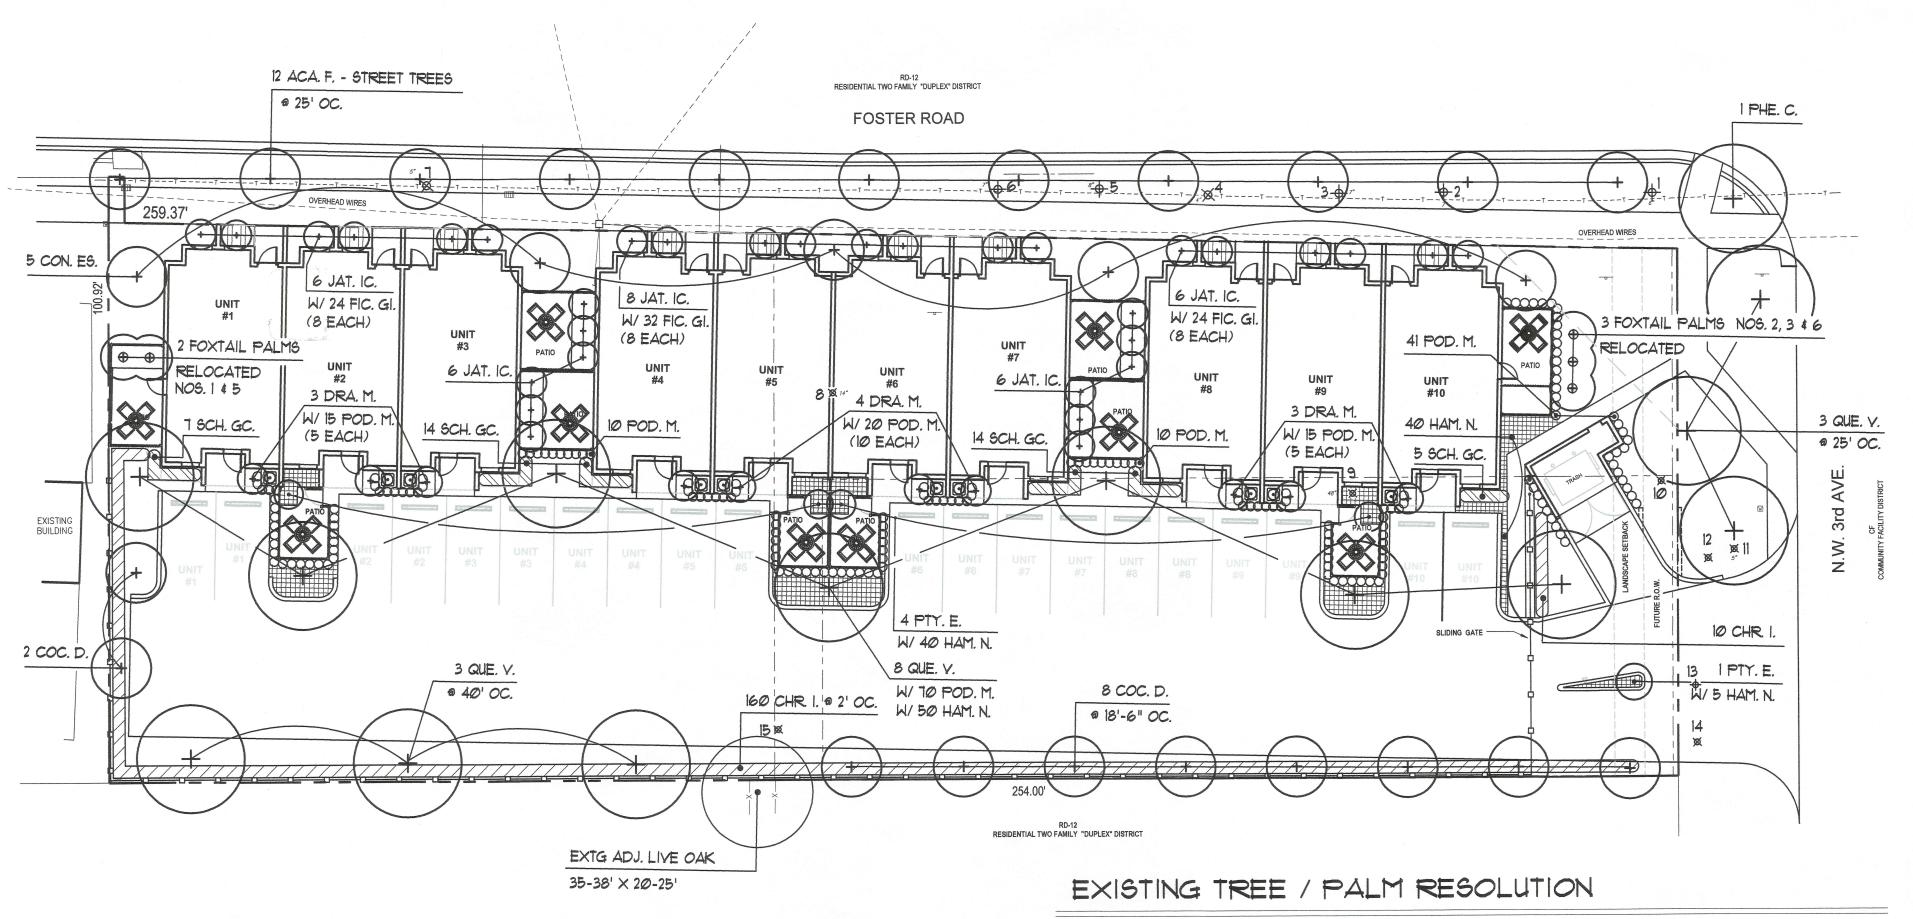
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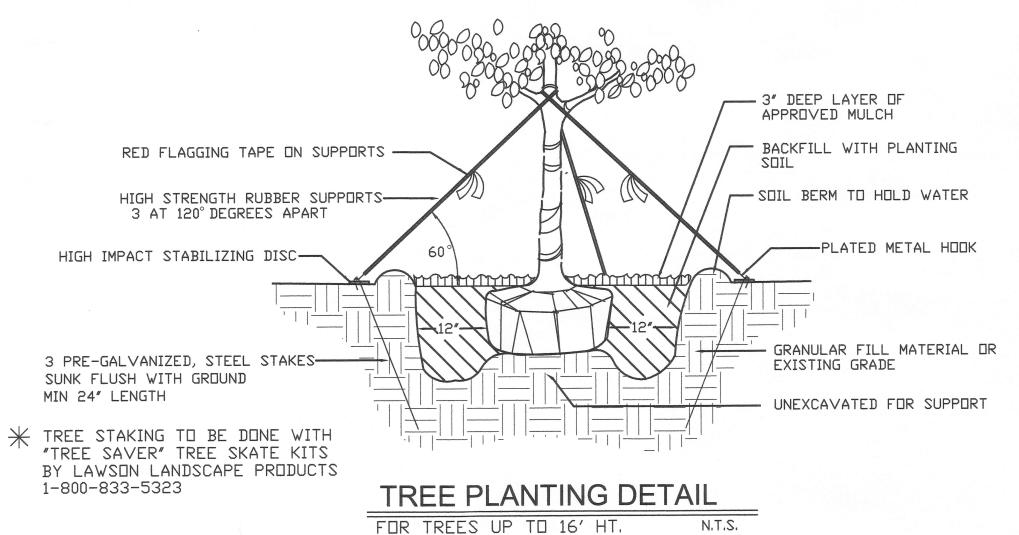
PRAWN: DC 3-12-2017

PROJECT NO: 2017-003

OMMO





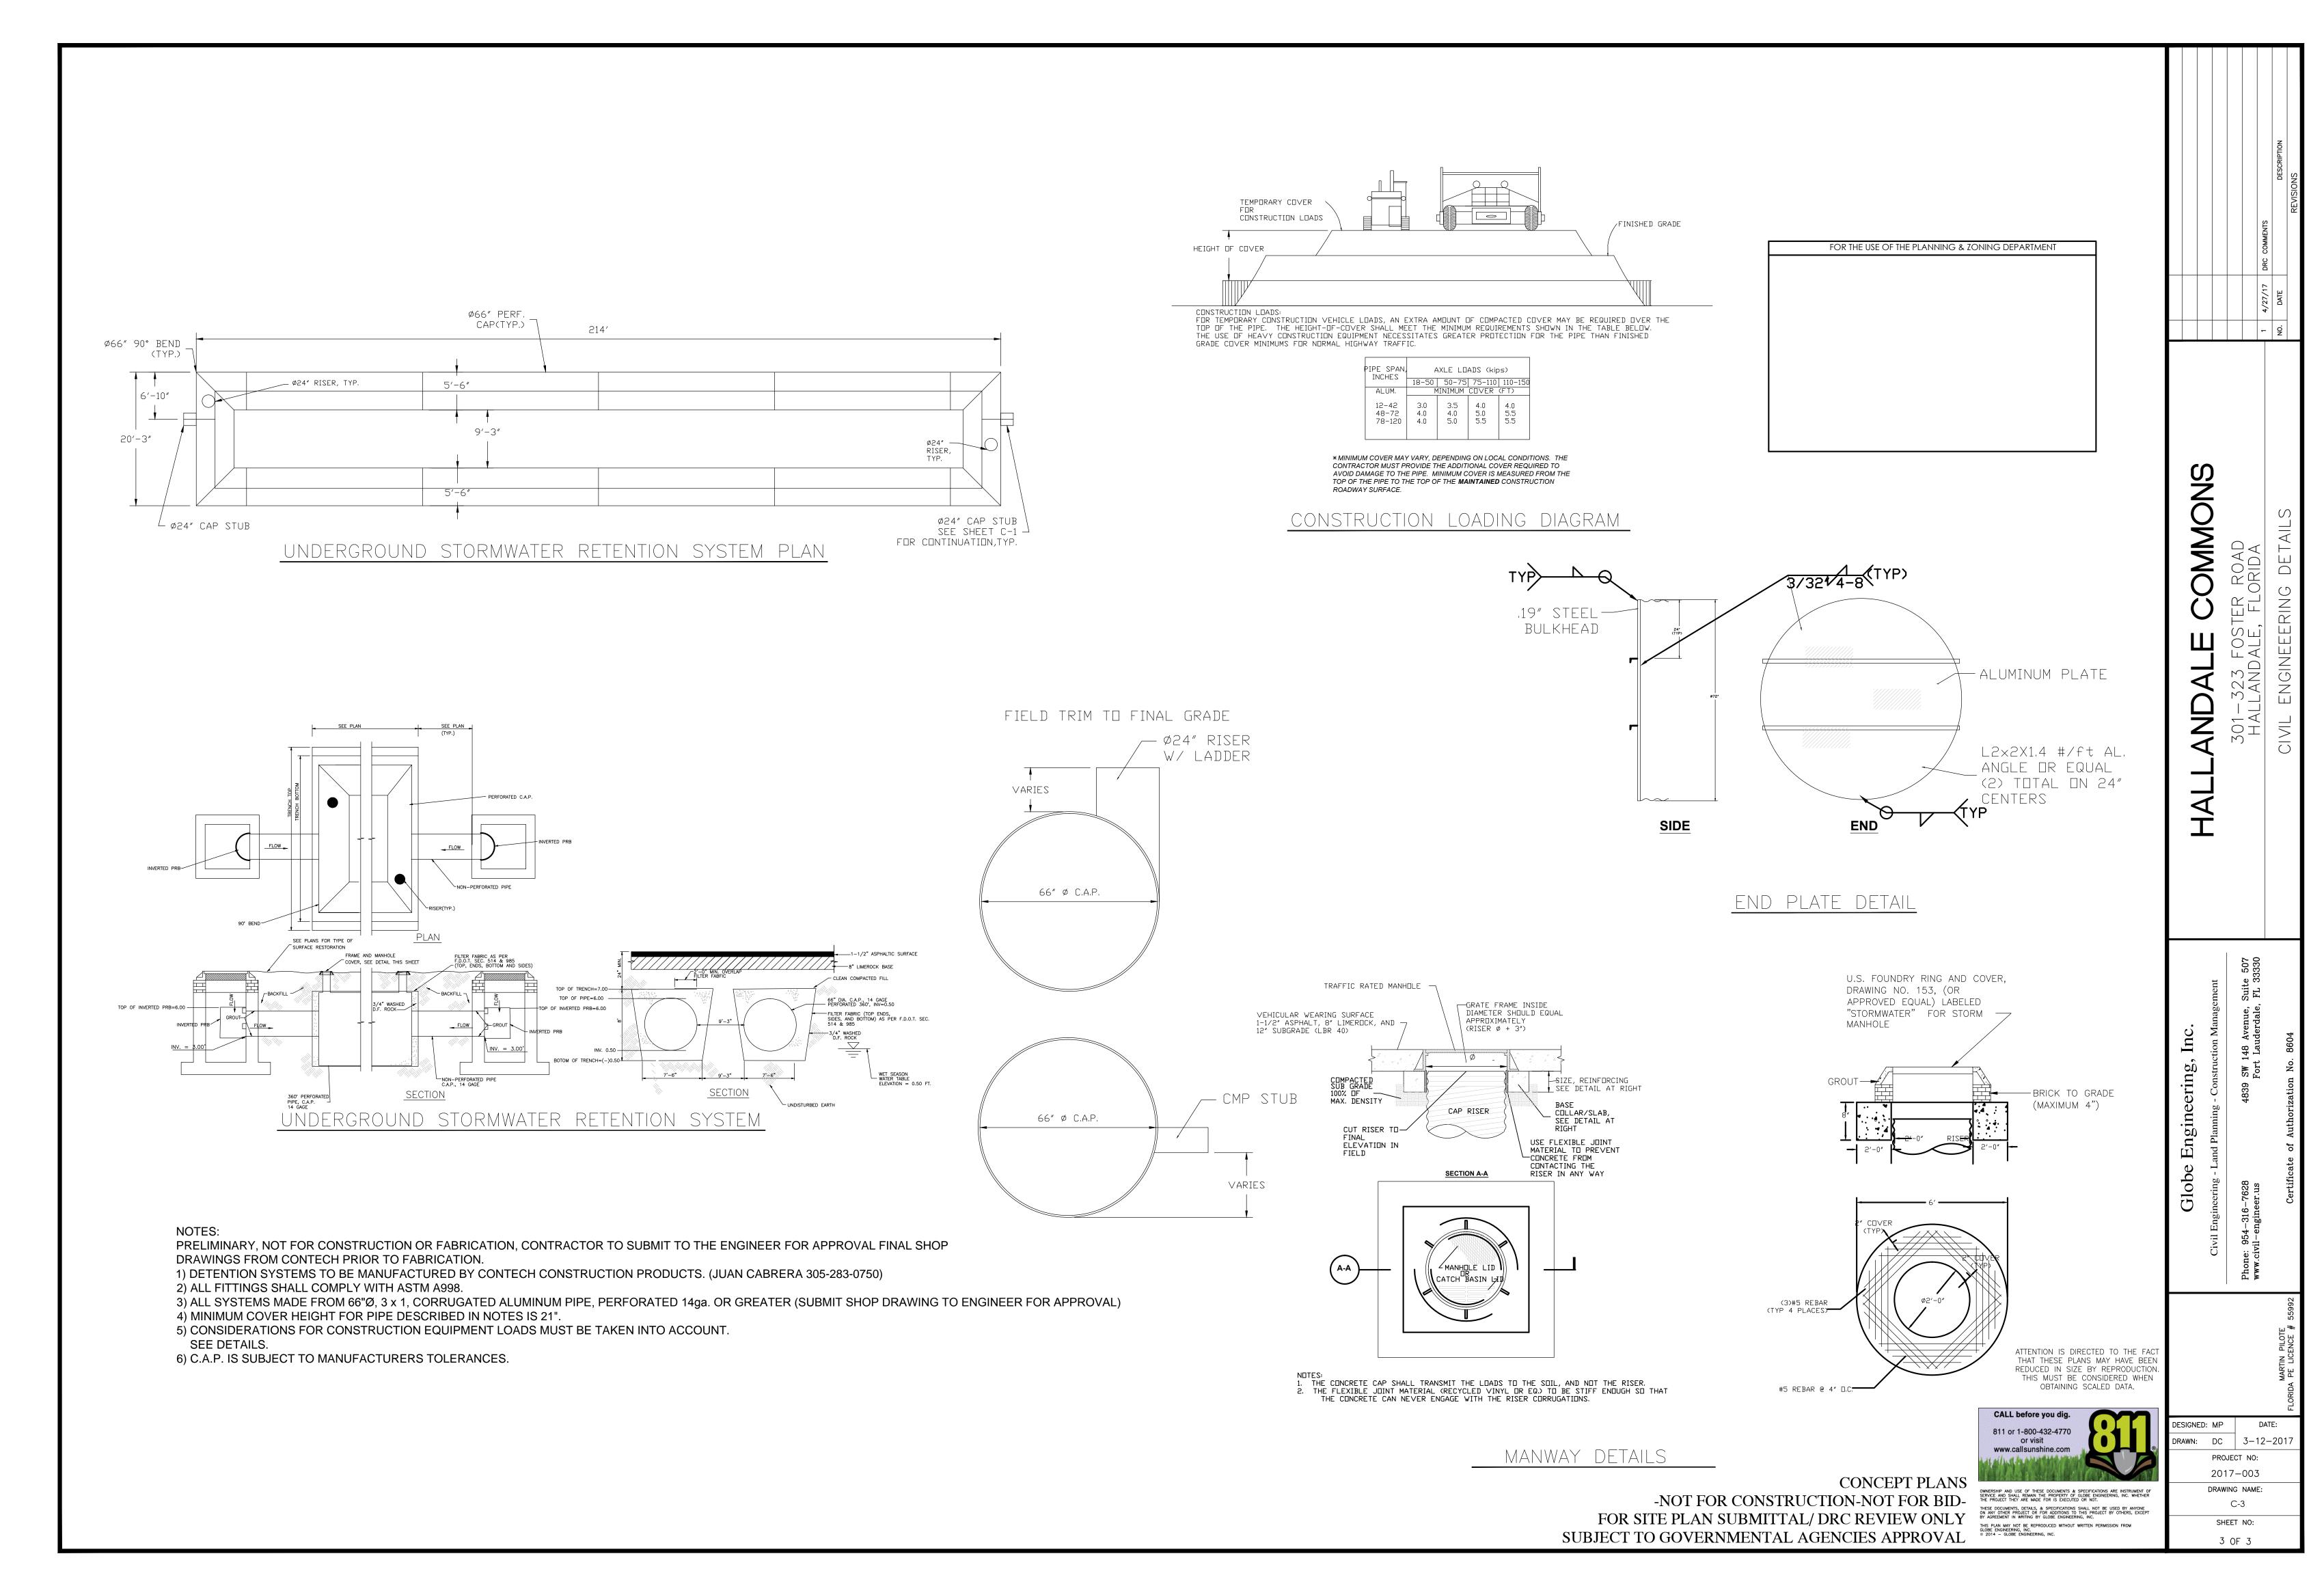

PLANT MATERIAL SHALL NOT BE ———————————————————————————————————
AFTER PLANTS HAVE BEEN  7
INSTALLED, EACH PLANT SHALL  APPROVED MULCH
BE PRUNED FOR UNIFORMITY.
GROUNDCOVER SPACING
ATTENDED TO THE PROPERTY OF TH
STRING AND REMOVE BURLAP (SEE PLANT LIST)
FROM TOP OF ROOT BALL.
000000000000000000000000000000000000000
BACKFILL WITH PLANTING SOIL SON
DACKIEL WITH LANGUAGE SEED OF
GRANULAR FILL MATERIAL OR EXCAVATE TO A MINIMUM DEPTH
EXISTING GRADE
PLANTING SOIL

## SHRUB PLANTING DETAIL

BOTANICAL/COMMON NAME/SIZE	CONDITION	RESOLUTION	MITIGATION
WODYETIA BIFURCATA/FOXTAIL PALM 13-16' X 4-7'/7-8" CAL	FAIR TO GOOD	TO RELOCATE	NONE
WODYETIA BIFURCATA/FOXTAIL PALM 13-16' X 4-7'/4-5" CAL	POOR	TO REMOVE	200 SF
MANIGIFERA INDICA/MANGO 18-20' X 12-13'/LOW CROTCH 3 TRK		TO REMOVE	453 SF
FLORIDA HOLLY	FAIR	TO REMOVE	NDNE
CODIAEUM/CROTON 8' X 4'	POOR	TO REMOVE	NONE
JATROPHA SPP./JATROPHA 11-12'X 10-111'/3-4"CAL	PDDR	TO REMOVE	314 SF
IXORA SHRUB	POOR	TO REMOVE	NONE
SABAL PALMETTO/SABAL PALM 8'CT/ 16-18'HT/13"CAL	GDDD	TO RELOCATE	NONE
ARAUCARIA SPP./N.ISLAND PINE 45-50'X 1-22'/18"CAL	FAIR	TO REMOVE	400+/- SF
FLORIDA HOLLY 30'X 25'/MULTISTEM	FAIR TO GOOD	TO RÉMOVE	NONE
		25' /MULTISTEM	

#### NEW TREES

13 LIVE DAKS @ 16'X 6'@ 500 SF/EACH

= MIN 6500 SF DF CANDPY ADDED

#### HALLANDALE LANDSCAPE CODE

1. TREES FOR SITE AREA	a shelp a	
TREE/PALM MIN. 10'HT PER 1500 SF OF TOTAL SITE		
TOTAL SITE = 23748 SF	16	21-F 11 LIVE DAK
		_ 10 PIGEON PLUM

14

2. STREET TREES (FOSTER ROAD & 3RD AVENUE ONLY)
350 LF / 25' =

16 - 12 SWEET ACACIA 1 DATE PALM 3 LIVE DAKS

#### PLANT LIST

	TREES & PA	LMS ( ALL TREES TO BE	BALLED & BURLAPED	AND FIELD GROWN)
	SYMBOL QTY	BOTANICAL NAME	COMMON NAME	SIZE
	ACA. F. 12	ACACIA FARNESIANA	SWEET ACACIA	15-16' X 6-7' /MIN. 4" DBH & 6' CT
*	COC. D. 10	COCCOLOBA DIVERSILFOL	IA PIGEON PLUM	10' X 4-5'/MIN 2"DBH & 4'CT
*	CON. ES. 5	CONOCARPUS E. "SERCIEU	S" SILVER BUTTONWO	DD 12'X 4-5'/MIN 2.5" DBH & 5'0
	PHE. C. 1	PHEDNIX CARNARIENSIS	CANARY I. D. PALM	23-24' HT/MIN/6-7' CT.
	PTY. E. 4	PTYCHOSPERMA ELEGANS	ALEXANDER PALMS	10-12' HT/MIN/6-7' CT.
V	QUF. V. 14	QUERCUS VIRGINIANA	LIVE DAK	15-16' X 6-7'/MIN 4"DBH & 6'C

*	CHR. I.	180 CHRYSOBALANUS ICACO	COCOPLUM	24" X 24"@ 24" OC.
	DRA. M.	10 DRACEANA MARGINATA	DRACEANA	6-7' X 2-3' /MIN 5 STE
	FIC. GI.	80 FICUS"GREEN ISLAND"	GRN. ISLAND FICUS	12-14" DA @18" DC.

HAM. N. 140 HAMELIA NODOSA DWARF FIREBUSH 18-24" DA @ 24" DC.

JAT. IC. 32 JATROPHA I. "COMPACTA" DWARF JATROPHA 6-7' X 3-4'/SPECIMENS

PDD. M. 181 PDDDCARPUS MACROPHYLLA PDDDCARPUS 4-5' X 18"@ 18" DC.

SCH. GC. 40 SCHEF. "GDLD CAPELLA" DW. VAR. SCHEFFLERA 24" X 24" @ 24" DC.

\*\* NATIVE MATERIALS - NEW TREES & PALMS -29 DUT DF 46 = 64%

SHRUBS & GROUND COVERS -320 DUT DF 663 = 49%

#### GENERAL LANDSCAPE NOTES

- 1. CONTRACTOR IS RESPONSIBLE FOR REPAIRING FACILITIES HE DAMAGES AND IS TO COORDINATE WITH OTHER CONTRACTORS ON SITE.
- 2. CONTRACTOR IS RESPONSIBLE FOR FINISH GRADES- ROUGH GRADES BY GENERAL
- 3. ALL PLANT MATERIALS TO BE FLORIDA NO. 1 OR BETTER AS PER FLORIDA DEPT. OF AGRICULTURE GRADES & STANDARDS, CURRENT EDITION
- 4. PLANTING SOIL TO BE A WEED FREE MIXTURE OF MUCK & SAND (50/50) WITH 50 LBS OF AN ORGANIC (6-6-6) FERTILIZER CONTAINING NITROGEN, PHOSPHORIC ACID AND POTASH IN AN EQUAL PERCENTAGE OF PLANT FOOD BY WEIGHT PER 6 CU. YDS..
- 5. TREES, PALMS, SHRUBS GUARANTEED FOR ONE (1) YEAR.
- 6. APPLY 3" MELALEUCA\EUCALYTUS MULCH (ARSENIC FREE) ARDUND ALL PLANTS
- 7. CONTRACTOR TO COMPLY WITH ALL CITY LANDSCAPE ORDINANCE REQUIREMENTS.
- 8. WHERE THERE IS A DISCREPENCY EITHER IN QUANTITIES, PLANT NAMES, SIZES OR SPECIFICATIONS BETWEEN THE PLAN OR PLANT LIST, THE PLAN TAKES PREFERENCE. THE LANDSCAPE CONTRACTOR IS RESPONSIBLE FOR ANY VERIFICATION NECESSARY INVOLVING THE LANDSCAPE MATERIALS SHOWN ON THE PLAN.
- 9. ALL AREAS NOT COVERED BY PAVING, STRUCTURES, OR LANDSCAPING TO BE SODDED ST AUGUSTINE FLORATAM SOD. SOD TO HAVE GOOD COMPACT GROWTH & ROOT SYSTEM. LAY WITH TIGHT JOINTS AND ROLL SMOOTH AS REQUIRED.
- 10. TREES & PALMS TO BE STAKED AS NECESSARY IN A GOOD WORKMANLIKE MANNER WITH NO NAIL STAKING PERMITTED.
- 11. THE IRRIGATION SYSTEM WILL HAVE 100% COVERAGE, 100% OVERLAP, NO OVER SPRAY ON WALKWAYS, PAINT PVC RISERS FLAT BLACK, RAIN SENSOR AND RUST FREE WATER. RECYCLED WATER WILL BE USED SO PURPLE PIPE WILL NEED TO BE USED AS WELL


#### TREE / PALM LEGEND

Management of the control of the con	
+	NEWLY PLANTED TREES
$\odot$	NEWLY PLANTED PALMS
$\odot$	PALM - TO REMAIN
<b>(</b>	RELOCATED PALM

+ PALM - TO BE RELOCATED

▼ TREE/PALM - TO BE REMOVED



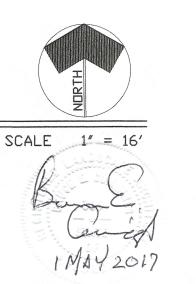

ISSUE / REVISION

12 MAR 2017

20 MAR 2017

18 APR 2017

1 MAY 2017


LANDSCAPE ARCHITECTS
LAUDERDALE BY THE SEA, FLA



TI COMMON®

エタロスターコタエ

CAD FILE: WESTARCHITECTL

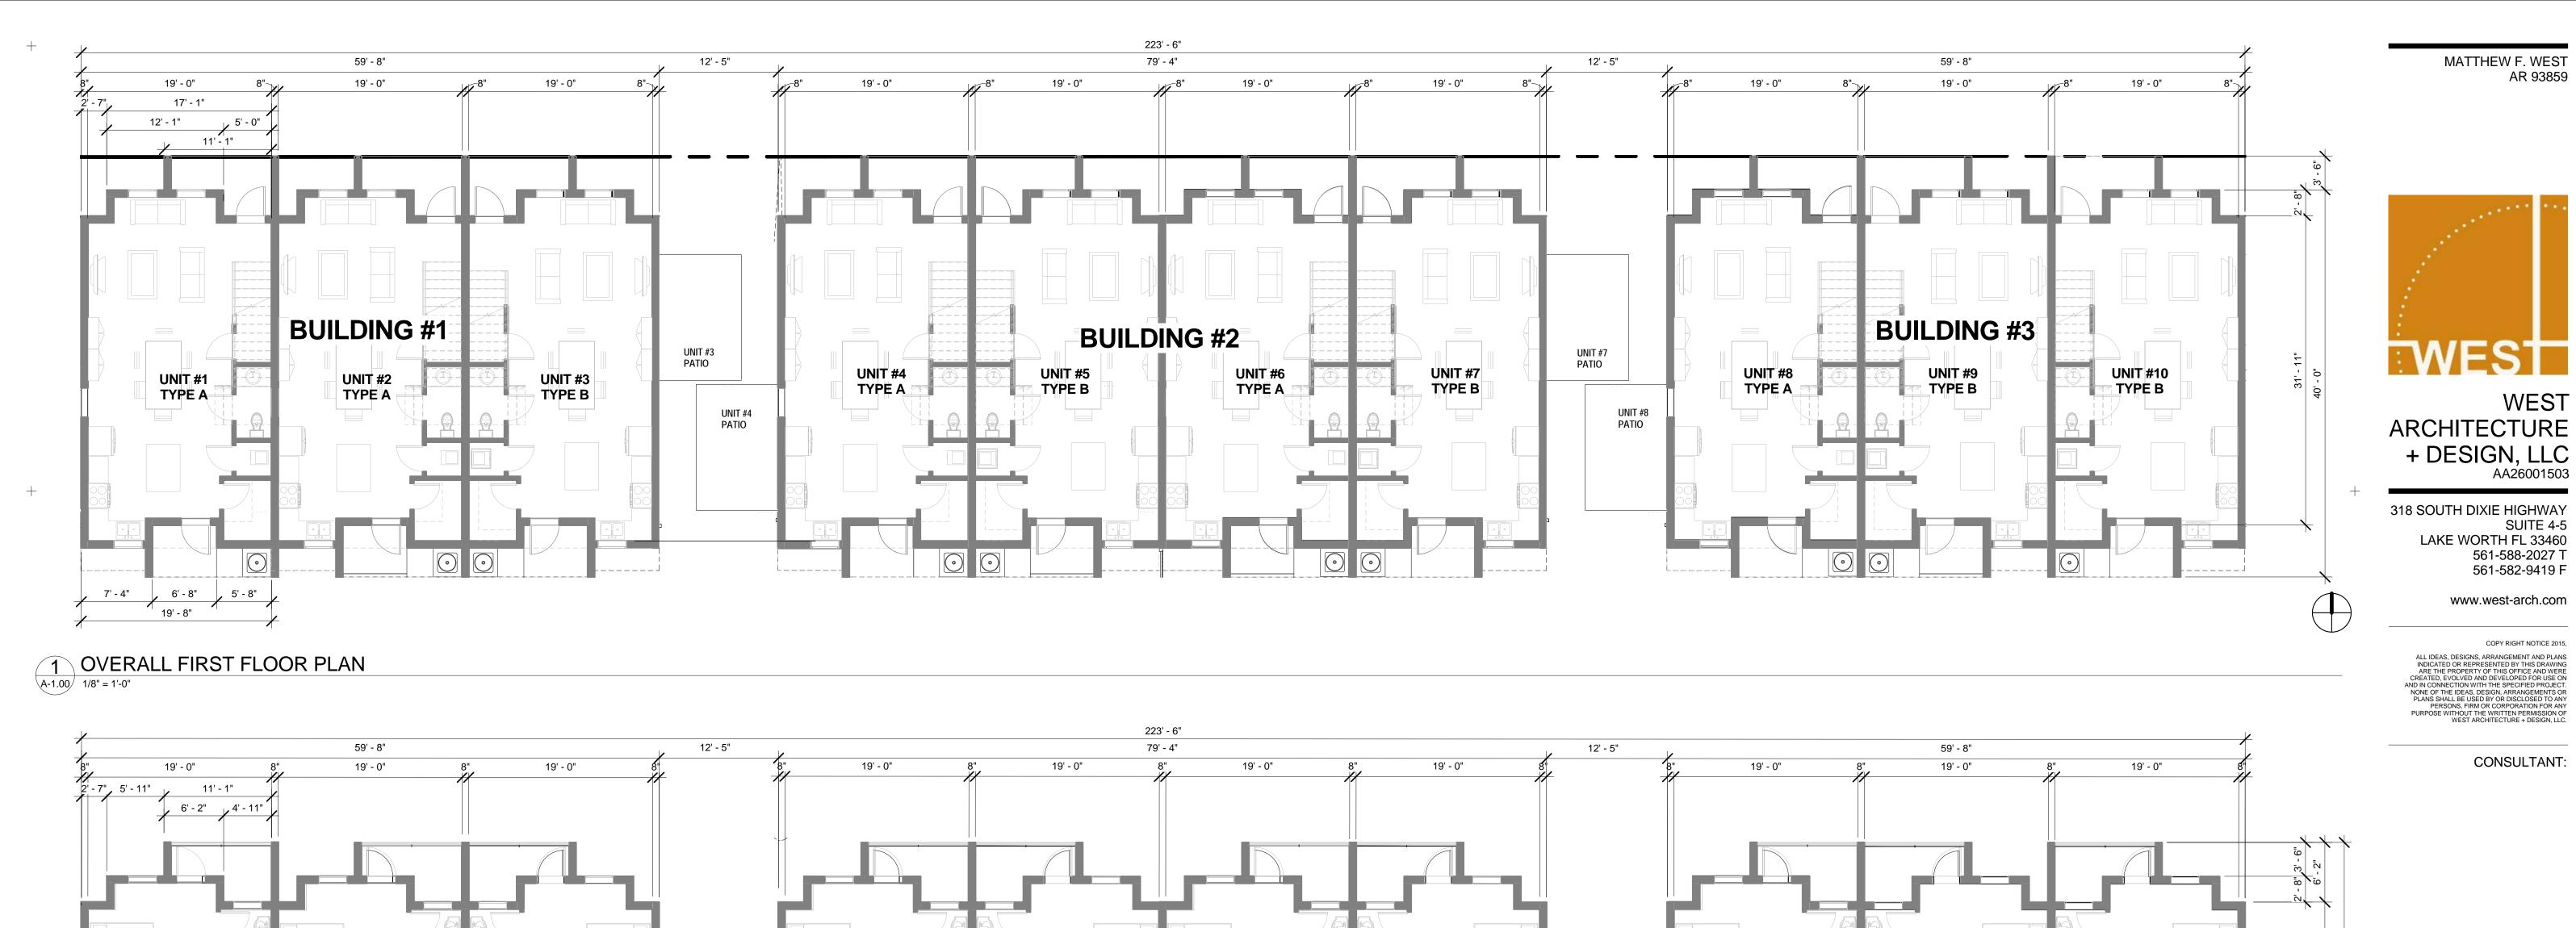

**BUILDING #2** 

UNIT #5

TYPE B

UNIT #4

TYPE A

UNIT #6

TYPE A

UNIT #7 TYPE B

**HALLANDALE** 

DESIGN & BUILD FOR:

**BUILDING #3** 

UNIT #9

TYPE B

UNIT #8

TYPE A

UNIT #10 TYPE B

FOR THE USE OF THE PLANNING & ZONING DEPARTMENT

MATTHEW F. WEST AR 93859

WEST

SUITE 4-5 LAKE WORTH FL 33460

561-588-2027 T 561-582-9419 F

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CONSULTANT:

COMMONS

301-323 FOSTER RD. HALLANDALE BEACH FL

DATE: 03-16-2017 A16-011 NUMBER: REVIEWED:

MANAGED: DRAWN:

**REVISION:** 

PRELIMINARY SET NOT FOR CONSTRUCTION

**OVERALL FLOOR PLANS** 

12' - 4"

19' - 8"

OVERALL SECOND FLOOR PLAN

1/8" = 1'-0"

UNIT #2


TYPE A

UNIT #1 TYPE A

**BUILDING #1** 

UNIT #3 TYPE B



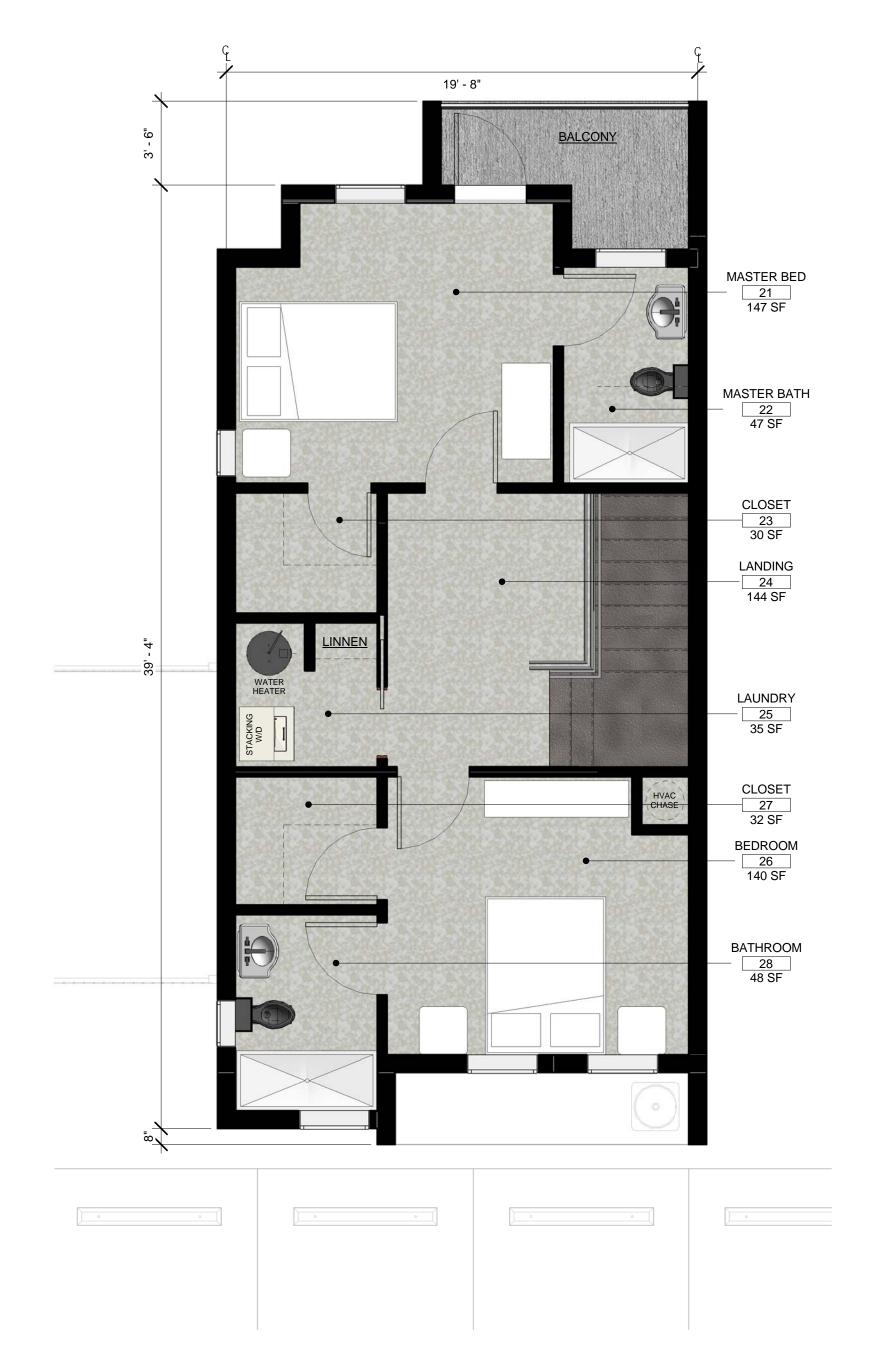

PLAN NOTES:

1. CONTRACTOR TO VERIFY ALL FIELD CONDITIONS PRIOR TO COMMENCEMENT AND REPORT ANY DISCREPANCIES TO THE ARCHITECT.

FOR THE USE OF THE PLANNING & ZONING DEPARTMENT

2. PROVIDE SOLID WOOD BACKING FOR ALL WALLS TO RECEIVE COUNTERS, CABINETS, DOOR STOPS, SINKS, TOILET ACCESSORIES, CHAIR RAILS AND OTHER RATED INSTALLATIONS. THE INSTALLATIONS SHALL BE REVIEWED BY THE OWNER/ARCHITECT PRIOR TO COVERING.

MATTHEW F. WEST AR 93859

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CONSULTANT:

DESIGN & BUILD FOR :

## **HALLANDALE** COMMONS

301-323 FOSTER RD. HALLANDALE BEACH FL

DATE: 03-16-2017 NUMBER: A16-011

REVIEWED: MANAGED: DRAWN:

REVISION:

PRELIMINARY SET NOT FOR CONSTRUCTION

**UNIT TYPE "A" FLOOR PLANS** 

TYPICAL "UNIT TYPE A" FIRST FLOOR PLAN

+ (A-1.10) 1/4" = 1'-0"

2 TYPICAL "UNIT TYPE A" SECOND FLOOR PLAN

A-1.10 1/4" = 1'-0"





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## HALLANDALE COMMONS

## 301-323 FOSTER RD. HALLANDALE BEACH FL

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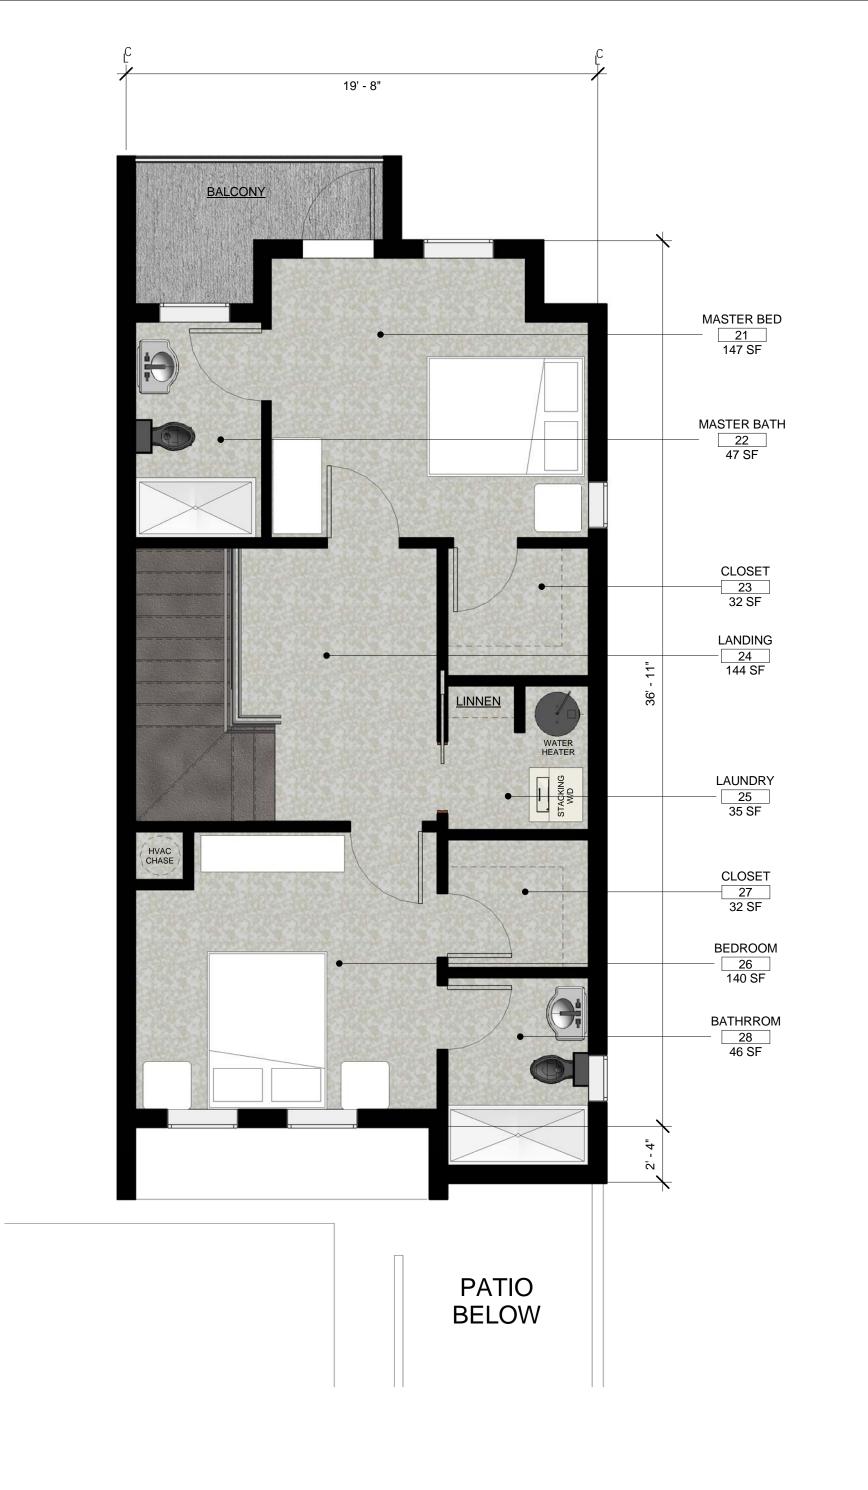
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REVIEWED:

REVISION:

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**UNIT TYPE "B" FLOOR PLANS** 



**ADJACENT UNIT** 

19' - 8"

STREET ENTRY

LIVING
11
209 SF

CRAWL 17 20 SF

DINING 12 179 SF

BATHROOM
16
27 SF

MECHANICAL

15

13 SF

KITCHEN

13

137 SF

CLOSET
14
31 SF

**ADJACENT UNIT** 

1 TYPICAL "UNIT TYPE B" FIRST FLOOR PLAN
A-1.20 1/4" = 1'-0"

2 TYPICAL "UNIT TYPE B" SECOND FLOOR PLAN

A-1.20 1/4" = 1'-0"

WEST

+ DESIGN, LLC AA26001503

SUITE 4-5 LAKE WORTH FL 33460

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**HALLANDALE** 

301-323 FOSTER RD.

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REVISION:

HALLANDALE BEACH FL

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A16-011 MFW


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CONSULTANT



## **ROOF NOTES:**

1. THE ROOF SYSTEM SHALL BE AS SPECIFIED OR APPROVED EQUAL

2. ALL ROOFING INSTALLATION METHODS, CONNECTIONS, ATTACHMENTS, OVERLAPS, PENETRATIONS, FLASHINGS AND DETAILS SHALL MEET THE SUBMITTED AND APPROVED ROOF SYSTEMS PRODUCT APPROVAL AND MANUFACTURES SPECIFICATIONS.

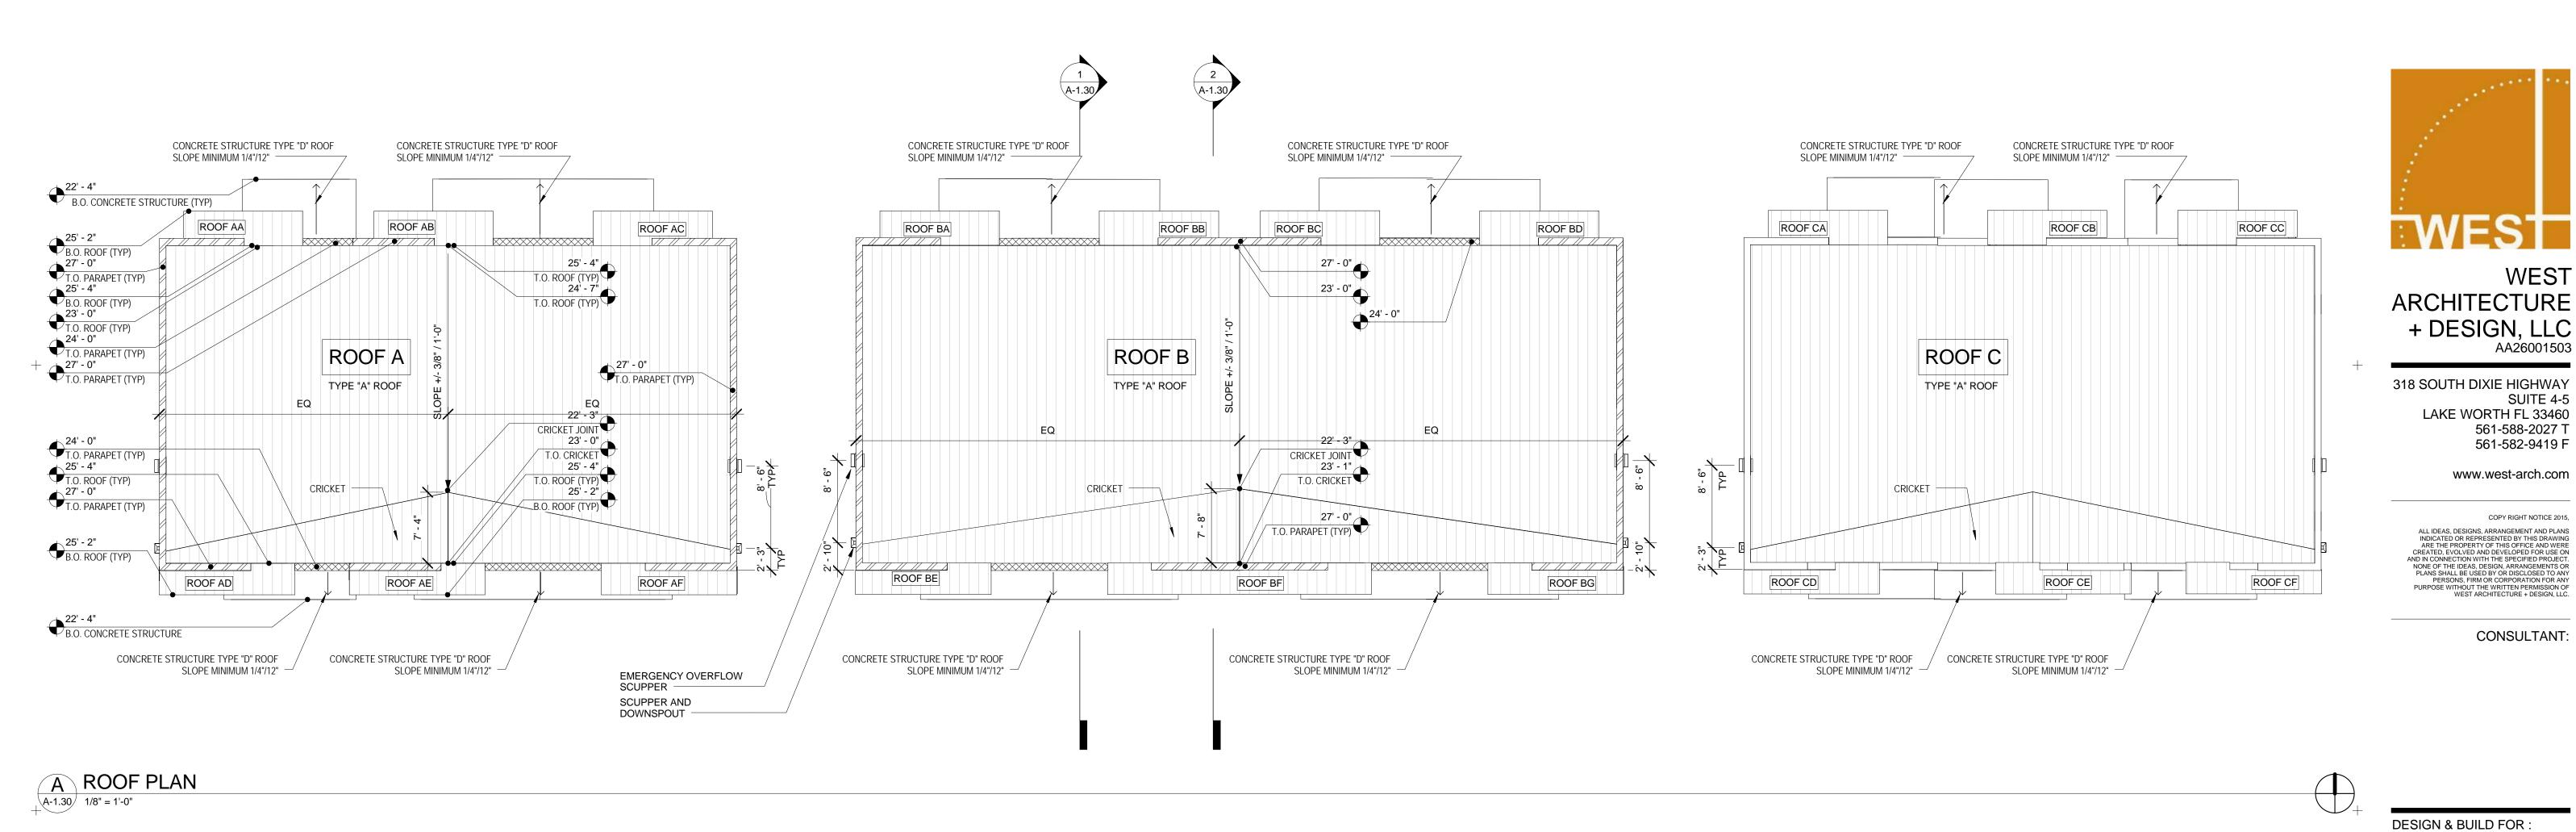3. ALL EXPOSED METAL SHALL BE GALVANIZED AND APPROPRIATE FOR COASTAL WEATHER

4. PROVIDE FLASHING AT ALL WALL AND CURB ADJOINMENTS.

5. MINIMUM 26 GAUGE GALVANIZED SCUPPERS AT ALL SCUPPER LOCATIONS. (OR APPROVED EQUAL)

6. SEE THE CIVIL DRAWING FOR SITE DRAINAGE.

7. COORDINATE LOCATIONS AND EXACT SIZES OF OPENINGS FOR PLUMBING PIPING WITH PLUMBING CONTRACTOR.

8. ROOF DRAINAGE PER FLORIDA PLUMBING CODE - 2010. CHAPTER 11 AND FLORIDA BUILDING CODE -SECTION 1503.4 ROOF DRAINAGE.

9. OVERFLOW DRAINS OR SCUPPERS SHALL BE PLACED TO PREVENT AN ACCUMULATION OF MORE THAN TWO INCHES OF WATER ON ANY PORTION OF THE ROOF.

10. ALL ROOFS SHALL BE DESIGNED WITH A MINIMUM SLOPE AT A MAXIMUM DEFLECTION PLUS ONE-QUARTER INCH PER FOOT TO ASSURE ADEQUATE

#### **ROOF TYPES**

#### TYPE "A"

MODIFIED BITUMEN ROOFING SYSTEM OVER WOOD DECK AS

MEMBRANE TYPE: SBS MODIFIED DECK TYPE: WOOD, INSULATED INSULATION LAYER: ANY APPROVED POLYISOCYANURATE OR

SECUROCK GYPSUM-FIBER ROOF BAORD MINIUM .5" THICK. BASE SHEET: SOPRAFIX BASE 622 ATTACH BASE SHEET USING SOPRAFIX MBB-R FASTENING:

IN THE MINIMUM 5" WIDE GAP MEMBRANE: SOPRELENE FLAM 180 FR GR

-90 PSF (SEE GENERAL LIMITATION #7 ON NOA) PRESSURE:

#### LOW SLOPED ROOF - CONCRETE EYEBROW

R NOVA PLUS WHITE PRODUCT SPECIFICATION ASTM D6083

CONTAINER SIZE 5 GAL. PAIL HYBRID ACRYLIC / URETHANE RESIN USED AS USE BASE OR TOP COAT

PARAPET WALLS. 5. PROVIDE CRICKETS AS REQUIRED TO ACHIEVE PROPER DRAINAGE. FOR THE USE OF THE PLANNING & ZONING DEPARTMENT

PRELIMINARY SET NOT FOR CONSTRUCTION

**ROOF PLAN** 

	ROOF AD ROOF A	ROOF A2	ROOF BE	ROOF BF	PROOF BG	ROOF CD ROOF	ROOF C2
	ROOF AREA	A LEGEND					
27' - 0 25' - 4 25' - 2	5/8" / 1'-0"	23' - 0"	3/8" / 1'-0"	25' - 2" 25' - 4" 23' - 1" 22' - 3"	1 1/4" / 1'-0"		RAPET LEVEL 2 27' - 0"  RAPET LEVEL 1 25' - 4"  BASE OF ROOF 22' - 0"
25' - 2 A-1.30 22' - 8 22' - 4	3/16" = 1'-0"	OOF SECTION  27' 24' 23'  OOF SECTION	3/8" / 1'-0"	22' - 2"	25' - 2" 25' - 4" 24' - 0" 22' - 10"		<del></del>

ROOF BA ROOF BB ROOF BC ROOF BD

ROOF AB

ROOF AC

#### **ROOF AREAS AND** DRAINAGE CALCULATIONS MAX ROOF DRAIN PROJECTED AREA

ROOF CB 7 ROOFCC

ROOF CA

	ROOF SIZE	VERTICAL WALL AREA / 2:	TTL CALCULATED AREA:	NOTES:
ROOF 'A'	2,119.1 SF	385.68 SF	2,504.78 SF	-
ROOF 'A1'	955.0 SF	169.23 SF	1,124.23 SF	-
ROOF 'A2'	955.0 SF	169.23 SF	1,124.23 SF	-
ROOF 'AA'	34.7 SF	6.24 SF	40.94 SF	-
ROOF 'AB'	34.7 SF	6.24 SF	40.94 SF	-
ROOF 'AC'	34.7 SF	6.24 SF	40.94 SF	-
ROOF 'AD'	35.0 SF	9.5 SF	44.5 SF	-
ROOF 'AE'	35.0 SF	9.5 SF	44.5 SF	-
ROOF 'AF'	35.0 SF	9.5 SF	44.5 SF	-
ROOF 'B'	2,836.1 SF	462.9 SF	3,299.0 SF	-
ROOF 'B1'	1,279.5 SF	199.96 SF	1479.46 SF	-
ROOF 'B2'	1,279.5 SF	199.96 SF	1479.46 SF	-
ROOF 'BA'	34.7 SF	6.24 SF	40.94 SF	-
ROOF 'BB'	34.7 SF	6.24 SF	40.94 SF	-
ROOF 'BC'	34.7 SF	6.24 SF	40.94 SF	-
ROOF 'BD'	34.7 SF	6.24 SF	40.94 SF	-
ROOF 'BE'	35.0 SF	9.5 SF	44.5 SF	-
ROOF 'BF'	68.3 SF	19.0 SF	87.3 SF	-
ROOF 'BG'	35.0 SF	9.5 SF	44.5 SF	-
ROOF 'C'	2,119.1 SF	385.68 SF	2,504.78 SF	-
ROOF 'C1'	955.0 SF	169.23 SF	1,124.23 SF	-
ROOF 'C2'	955.0 SF	169.23 SF	1,124.23 SF	-
ROOF 'CA'	34.7 SF	6.24 SF	40.94 SF	-
ROOF 'CB'	34.7 SF	6.24 SF	40.94 SF	-
ROOF 'CC'	34.7 SF	6.24 SF	40.94 SF	-
ROOF 'CD'	35.0 SF	9.5 SF	44.5 SF	-
ROOF 'CE'	35.0 SF	9.5 SF	44.5 SF	-
ROOF 'CF'	35.0 SF	9.5 SF	44.5 SF	-

**ROOF DRAIN CALCULATIONS** 

VERTICAL LEADERS & ROOF GUTTERS- ( AS PER FLORIDA PLUMBING CODE, TABLE 1106.2-BASED ON 12 INCHES ANNUAL RAINFALL)

	ROOF SIZE	SIZE OF VERTICAL LEADERS	SIZE OF SEMICIRCULAR ROOF GUTTERS
ROOF 'A1'	1,124.23 SF	2 3/4" x 4 1/4"	N/A
ROOF 'A2'	1,124.23 SF	2 3/4" x 4 1/4"	N/A
ROOF 'B1'	1,479.46 SF	2 3/4" x 4 1/4"	N/A
ROOF 'B2'	1,479.46 SF	2 3/4" x 4 1/4"	N/A
ROOF 'C1'	1,124.23 SF	2 3/4" x 4 1/4"	N/A
ROOF 'C2'	1,124.23 SF	2 3/4" x 4 1/4"	N/A

MANUFACTURERED BY SOPREMA, INC.

WITH SOPREMA #15 FASTENERS SPACED 6" O.C.

TYPE "D"

BASE COAT 3.0 GAL/SQFT, TOP COAT 1.0GAL/SQFT

NOTES:

1. PROVIDE THE REQUIRED FLASHINGS AT EACH CONDITION. 2. PROVIDE A MINIMUM 15 YEAR GUARANTEE (OR APPROVED EQUAL) 3. ROOF DRAINAGE BY THRU WALL SCUPPERS, COLLECTION BOXES AND DOWNSPOUTS.

4. OVERFLOW DRAINAGE BY THRU WALL SCUPPERS LOCATED IN THE



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AR 93859

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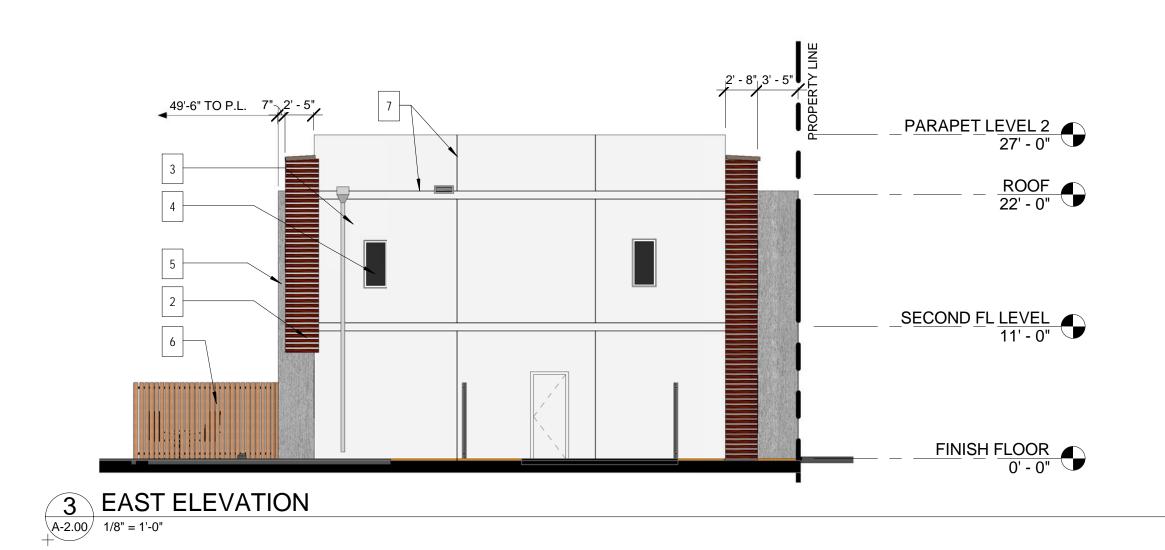
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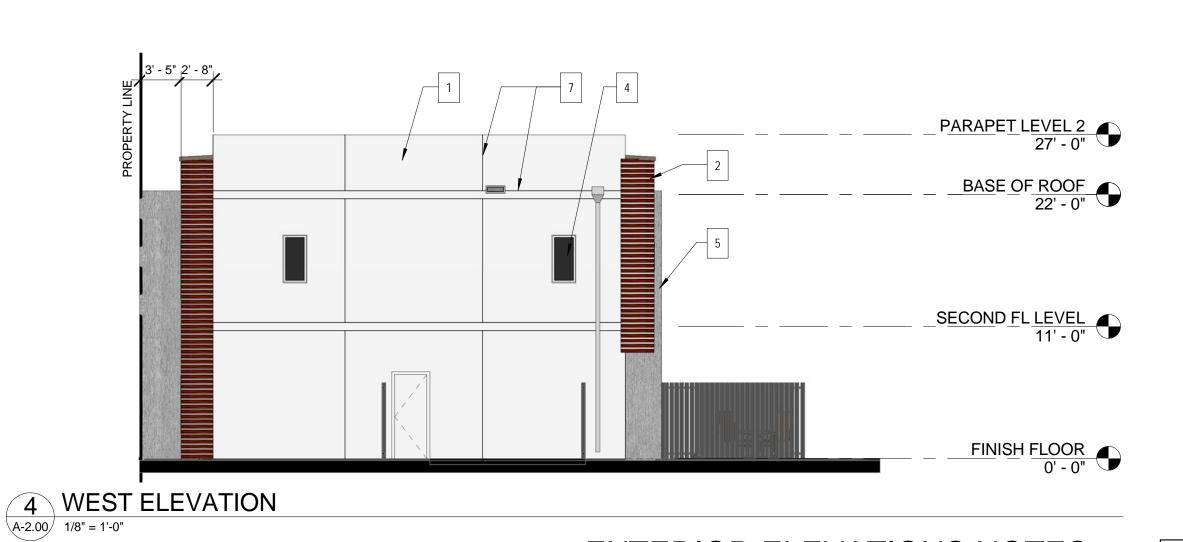
CONSULTANT:

1 NORTH ELEVATION



## 





## EXTERIOR ELEVATIONS NOTES:

1.STUCCO FINISHES TO BE FINE SAND FINISHED STUCCO, UNLESS NOTED OTHER WISE. PROVIDE 4'X4' MOCK UP FOR APPROVAL

FINISH MATERIAL LEGEND			
SYMBOL	DESCRIPTION	NAME / MANUF. / FINISH	
1	SCORED STUCCO 1	2172-10 COPPER CLAY/BENJAMIN MOORE	
2	SCORED STUCCO 2	2165-40 DARK BEIGE/BENJAMIN MOORE	
3	SMOOTH STUCCO	WHITE (MANUF. STANDARD)/BENJAMIN MOORE	
4	WINDOW	TINTED, IMPACT RESISTANT	
5	CONCRETE STRUCTURE	SMOOTH CONCRETE, COLOR TBD	
6	FENCE	WOOD SHADOW BOX	
7	1/2" SCORELINE	TOOLED JOINT	

DESIGN & BUILD FOR :

## **HALLANDALE** COMMONS

## 301-323 FOSTER RD. HALLANDALE BEACH FL

DATE: 03-16-2017 NUMBER: A16-011 REVIEWED: MANAGED: DRAWN:

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1 04-27-2017 DRC COMMENTS

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**EXTERIOR ELEVATIONS** 



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## HALLANDALE COMMONS



DATE: 03-16-201

NUMBER: A16-01

REVIEWED: MFV

MANAGED: PC

REVISION:

DRAWN:

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RENDERINGS

A-2.10



VIEW FROM NW 3RD AVENUE ENTRANCE



VIEW FROM NORTHWEST



VIEW FROM NW 3RD AVENUE ENTRANCE

VIEW FROM RESIDENTS ENTRY