

NOTE: SEE ARCHITECTURAL PLANS FOR ASPHALT PAVEMENT LOCATION AND PAVER LOCATIONS


Joseph C Chan


Digitally signed by Joseph C Chan Date: 2022.06.29 10:50:31 -04'00'

THIS ITEM HAS BEEN DIGITALLY SIGNED AND SEALED BY JOSEPH CHAN ON THE DATE SHOWN ADJACENT TO THE SEAL

PRINTED COPIES OF THIS DOCUMENT ARE NOT CONSIDERED SIGNED OR SEALED THE SIGNTURE MUST BE VERIFIED ON ELECTRONIC COPIES.

JOSEPH CHAN , PE, PSM, CGC PE#40587

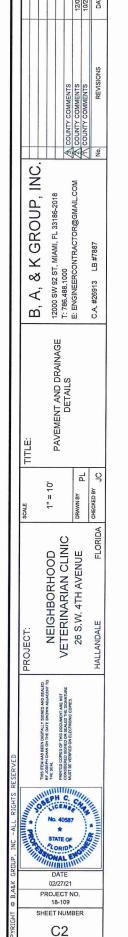

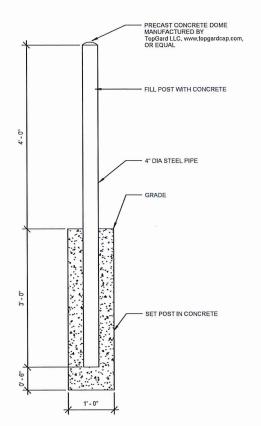

1 PIPE BOLLARD DETAIL
1" = 1'-0"

CALL 2 WORKING DAYS
BEFORE YOU DIG


IT'S THE LAW!
DIAL 811


Know what's below.
Call before you dig.

SUNSHINE STATE ONE CALL OF FLORIDA INC.

GENERAL NOTES

- ALL WORK TO BE IN COMPLIANCE WITH THE REQUIREMENTS OF AND ACCEPTABLE TO CITY/COUNTY COUNTY PUBLIC WORKS DEPARTMENT, AND S.F.W.M.D.
- 2. EXISTING UTILITIES AS SHOWN ARE PLOTTED FROM THE BEST AVAILABLE SOURCES, HOWEVER EITHER THE ENGINEER OF RECORD OR B, A, & K GROUP, INC. GUARANTEE THE ACCURACY. ANY ADDITIONAL COST DUE TO CONFLICT BETWEEN PROPOSED MPROVEMENTS AND EXISTING UTILITIES SHALL BE THE SOLE RESPONSIBILITY OF THE CONTRACTOR.

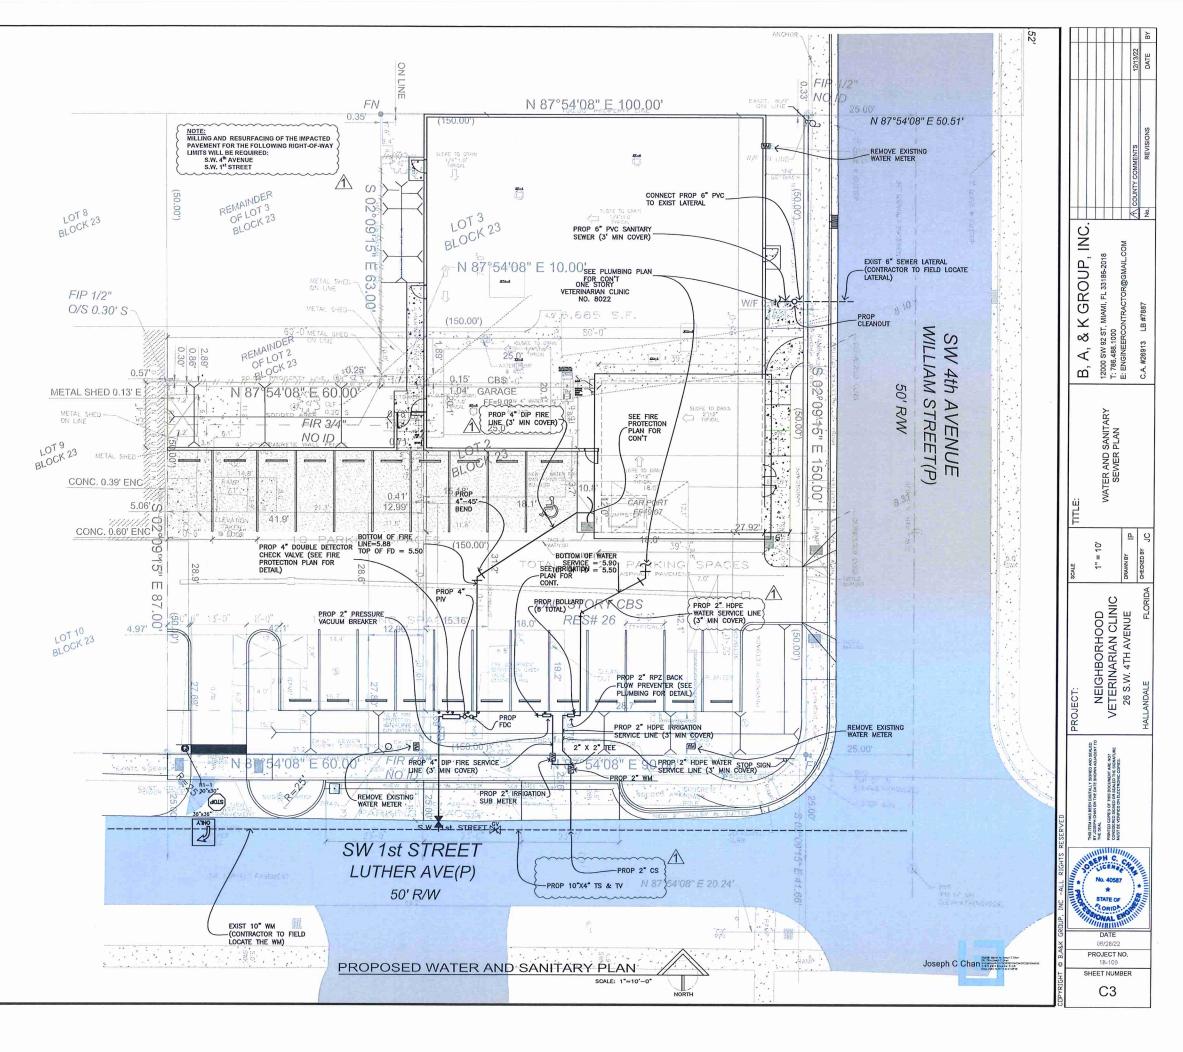

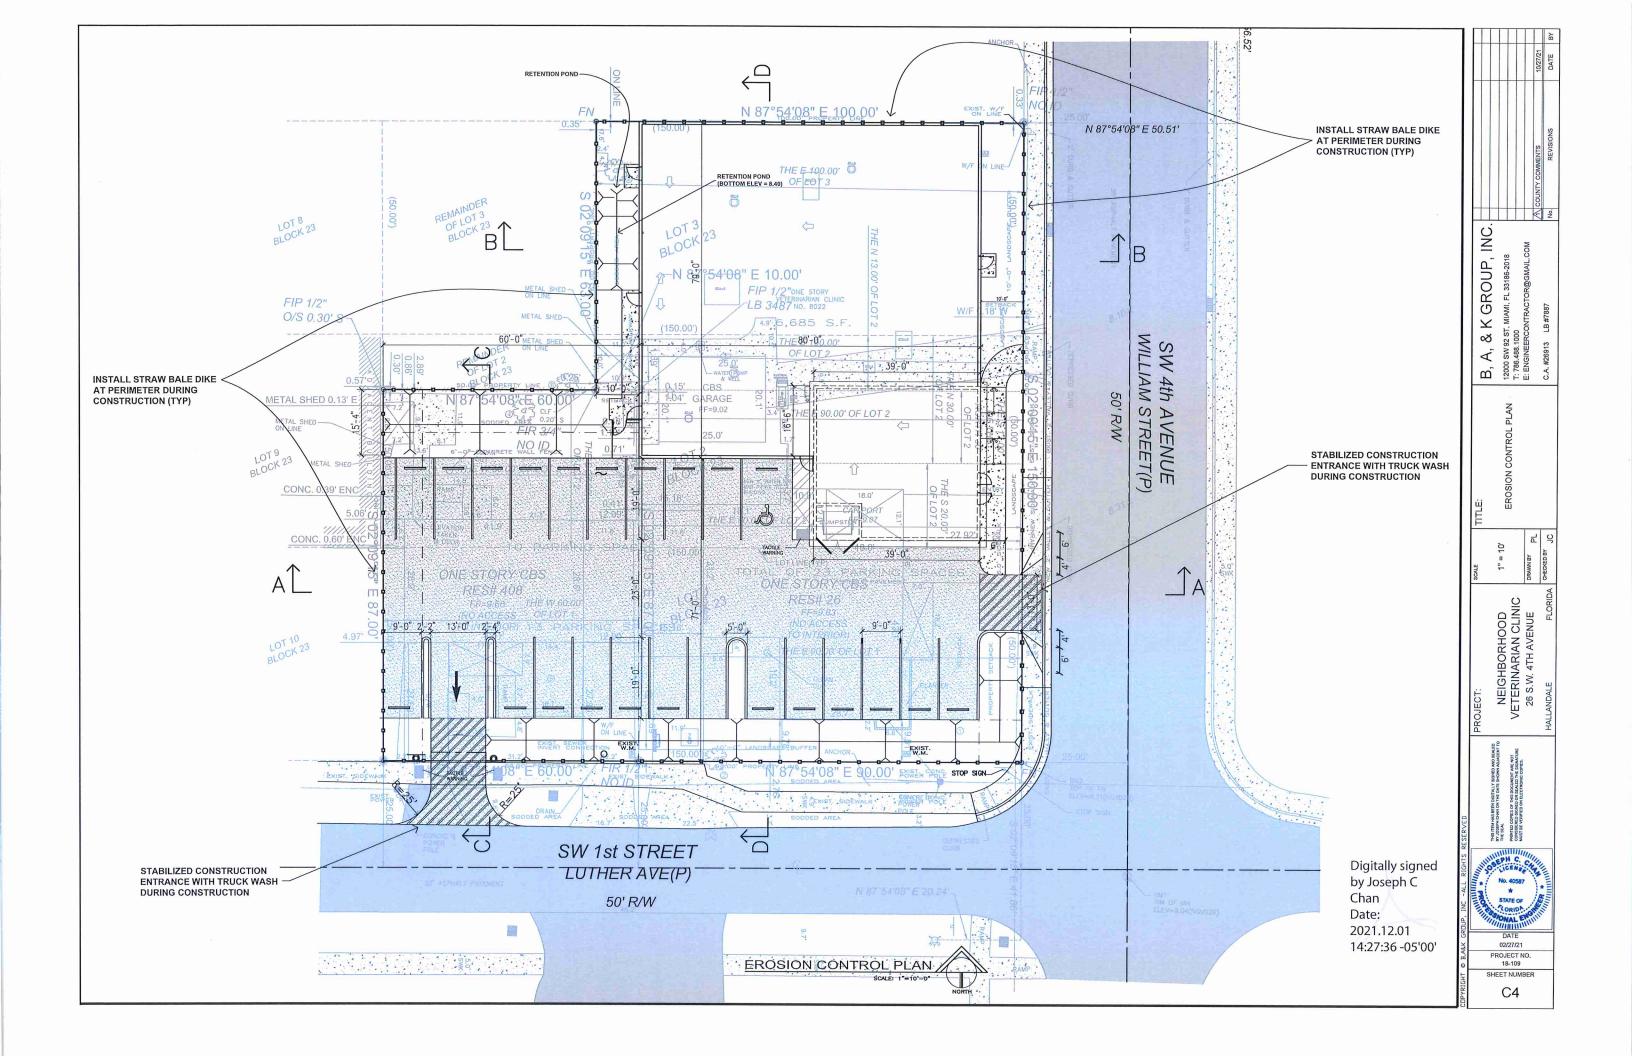

EROSION AND SEDIMENT CONTROLS

STABILIZATION PRACTICES:
ACCEPTABLE PRACTICES INCLUDE TEMPORARY SEEDING, PERMANENT SEEDING, MULCHING, GEOTEXTILES, SOD STABILIZATION, VEGETATIVE BUFFER STRIPS, FENCE PROTECTION OF TREES, PRESERVATION OF MATURE VEGETATION, STABILIZATION SHALL BE INITIATED NO MORE THAN 14 DAYS IN AREAS WHERE CONSTRUCTION ACTIVITIES HAVE TEMPORARILY OR PERMANENTLY CEASED.

CONTRACTOR SHALL MAINTAIN A RECORD OF DATES WHEN MAJOR GRADING ACTIVITIES OCCUR, WHEN CONSTRUCTION TEMPORARILY OR PERMANENTLY CEASES AND WHEN STABILIZATION IS INITIATED AND COMPLETED

STRUCTURAL PRACTICES:

ACCEPTABLE STRUCTURAL PRACTICES INCLUDE SILT FENCES, HAY BALES, EARTH DIKES, DRAINAGE SWALES, SEDIMENT TRAPS, CHECK DAMS, TURBIDITY BARRIERS, SUBSURFACE DRAINS, PIPE SLOPE DRAINS, LEVEL SPREADERS, STORM DRAIN INLET PROTECTION, ROCK OUTLET PROTECTION, REINFORCED SOIL RETAINING SYSTEMS, GABIONS, AND TEMPORARY OR PERMANENT SEDIMENT BASINS.

STRUCTURAL PRACTICES SHOULD BE PLACED ON UPLAND SOILS UNLESS SPECIFIED OTHERWISE BY THE FLORIDA WETLAND

STRUCTURAL PRACTICES SHOULD BE PLOCATED ON OPPLIES ONLESS SPECIFIED OTHERWISE BY THE PLORIDA WELDAND RESOURCE OR ENVIRONMENTAL RESOURCE PERMIT.

FOR DRAINAGE LOCATIONS SERVING MORE THAN 5 ACRES OF DISTURBED LAND AT ONE TIME, A SEDIMENT BASIN PROVIDING 3,600 CUBIC FEET OF STORAGE PER ACRE DRAINED OR EQUIVALENT MEASURE MUST BE PROVIDED UNTIL FINAL STABILIZATION

FOR DRAINAGE LOCATIONS SERVING LESS THAN 5 ACRES OF DISTURBED LAND AT ONE TIME, SEDIMENT BASINS OR TRAPS

SCHOMENT BASINS SHALL BE INSTALLED IN LOCATION OF PERMANENT STORM WATER RETENTION FACILITIES IF POSSIBLE. WHEN PERMANENT STORM WATER RETENTION PONDS ARE TO BE USED AS TEMPORARY SEDIMENT BASINS ACCUMULATED SEDIMENTS MUST BE COMPLETELY REMOVED AND EXCAVATION FOR TEMPORARY SEDIMENT BASIN SHALL NOT EXCEED INCHES ABOVE THE BOTTOM ELEVATION OF THE PERMANENT STORM WATER POND.

SILT FENCES OR EQUIVALENT SEDIMENT CONTROLS ARE REQUIRED FOR ALL SIDE SLOPE AND DOWN SLOPE BOUNDARIES OF THE CONSTRUCTION AREA.

STORM DRAIN INLETS SHALL BE PROTECTED FROM SEDIMENT LOADING DURING THE COURSE OF CONSTRUCTION BY THE USE OF SEDIMENT FILTERS OR AN EXCAVATED IMPOUNDING AREA PROPERLY INSTALLED AND MAINTAINED AROUND THE STORM DRAIN DROP OR CURB INLET. INLET PROTECTION SHALL REMAIN IN PLACE UNTIL PERMANENT STABILIZATION OF DISTURBED AREA TO KEEP POLLUTANTS FORM ENTERING THE CONVEYANCE SYSTEM.

EROSION CONTROL DEVICES TO BE INSTALLED IN ACCORDANCE WITH FLORIDA DEPARTMENT OF TRANSPORTATION ROADWAY AND TRAFFIC DESIGN STANDARDS, JANUARY 2000 (OR LATEST EDITION).

STORMWATER MANAGEMENT CONTROLS & BEST MANAGEMENT PRACTICES WATER QUALITY IS BEING PROVIDED THROUGH:

POLLUTION RETARDANT BAFFLES ARE TO BE INSTALLED AT THE UPSTREAM END OF THE OUTFALL PIPE TO THE CANAL

OFF-SITE VEHICLE TRACKING OF SEDIMENTS CONTROLS
OFF-SITE VEHICLE TRACKING OF SEDIMENTS AND GENERATION OF DUST SHALL BE MINIMIZED. CALCIUM CHLORIDE, OILS OR
OTHER CHEMICAL DUST CONTROL AGENTS SHOULD NOT BE USED ON CONSTRUCTION ROADS, AREAS SHALL BE
PERIODICALLY WATERED TO MINIMIZE DUST.

A STONE STABILIZED PAD SHALL BE LOCATED AT POINTS OF VEHICULAR INGRESS AND EGRESS ON THE CONSTRUCTION SITE TO AVOID TRANSPORTING SEDIMENTS TO OFF-SITE ROADS.

SPECIALLY DESIGNATED WASH AREAS FOR WASHING OF VEHICLES SHALL BE LOCATED WHERE WASH WATER WILL NOT DISCHARGE DIRECTLY TO SURFACE WATERS OR STORM WATER CONVEYANCE SYSTEMS. WASH AREAS SHALL BE LOCATED WHERE WASH WATER CAN SPREAD OUT AND EVAPORATE OR INFILTRATE DIRECTLY INTO THE GROUND OR WHERE RUNOFF CAN BE COLLECTED IN TEMPORARY HOLDING OR SEEPAGE BASIN. WASH AREAS SHALL HAVE GRAVEL BASES TO MINIMIZE MUD

MAINTENANCE

A REGULAR MAINTENANCE PROGRAM SHOULD INSURE INSPECTION AND MAINTENANCE OF BMPS BY THE CONTRACTOR WEEKLY AND/OR AFTER SIGNIFICANT RAIN EVENTS. ANY FAILURES SHOULD BE ANALYZED TO PREVENT RECURRENCE. SUBSTANTIAL CHANGES TO THE APPROVED PLAN MUST BE MADE OR REVIEWED BY THE DESIGNER AND APPROVED BY THE APPROPRIATE REGULATORY AGENCY, POLLUTION PREVENTION CONTROLS SHALL BE INSPECTED IMMEDIATELY AFTER EACH APPROPRIATE REGULATIOR ASSENCT. POLICITION PREVENTION CONTROLS STALL BE INSPECTIVE IMMEDIATELY AFTER RAINFALL AND AT LEAST DAILY DURING PROLONGED RAINFALL. ANY REPAIRS SHALL BE MADE HIMMEDIATELY SEDIMENT DEPOSITS SHALL BE REMOVED AFTER EACH STORM EVENT AND WHEN SEDIMENT HAS OVER ACCUMULATED. REMOVED SEDIMENT SHALL BE DEPOSITED IN A SUITABLE AREA IN SUCH A MANNER THAT IT WILL NOT ERODE.

EXAMPLE MAINTENANCE ROUTINES INCLUDE:

EXAMPLE MAINTENANCE ROUTINES INCLUDE:
SILT BARRIERS:
SEDIMENT MUST BE REMOVED WHEN DEPOSITS REACH APPROXIMATELY /2 THE HEIGHT OF THE BARRIER.
STORM DRAIN INLET PROTECTION:
SEDIMENT SHALL BE REMOVED AND THE TRAP RESTORED TO ITS ORIGINAL DIMENSIONS WHEN THE SEDIMENT HAS
ACCUMULATED TO 22 OF THE DESIGN DEPTH OF THE TRAP, STRUCTURES SHALL BE REMOVED AND THE AREA STABILIZED WHEN THE REMAINING DRAINAGE AREA HAS BEEN PROPERLY STABILIZED.

SEDIMENT SHALL BE REMOVED AND THE TRAP RESTORED TO ITS ORIGINAL DIMENSIONS WHEN THE SEDIMENT HAS

ACCUMULATED TO % THE DESIGN VOLUME OF THE TRAP.

THE STRUCTURE SHOULD BE CHECKED REGULARLY TO INSURE THAT IT IS STRUCTURALLY SOUND AND HAS NOT BEEN DAMAGED BY EROSION OR CONSTRUCTION EQUIPMENT. THE HEIGHT OF THE OUTLET SHOULD BE CHECKED TO ENSURE THAT ITS CENTER IS AT LEAST ONE FOOT (30 CM) BELOW THE TOP OF THE EMBANKMENT.

THE DEVELOPER/OWNER SHALL BE RESPONSIBLE FOR MAINTENANCE OF THE FILTER CURTAIN FOR THE DURATION OF THE PROJECT TO ENSURE THE CONTINUOUS PROTECTION OF THE WATERCOURSE. SHOULD REPAIRS TO THE GEOTEXTILE FABRIC BECOME NECESSARY, THERE ARE NORMALLY REPAIR KITS AVAILABLE FROM THE MANUFACTURERS;

MANUFACTURER'S INSTRUCTIONS MUST BE FOLLOWED TO ENSURE THE ADEQUACY OF THE REPAIR. WHEN THE CURTAIN IS NO LONGER REQUIRED AS DETERMINED BY THE INSPECTOR, THE CURTAIN AND RELATED COMPONENTS SHALL BE REMOVED IN SUCH A MANNER AS TO MINIMIZE TURBIDITY. SEDIMENT SHALL BE REMOVED AND THE ORIGINAL DEPTH (OR PLAN ELEVATION) RESTORED BEFORE REMOVING THE CURTAIN. REMAINING SEDIMENT SHALL BE SUFFICIENTLY SETTLED BEFORE REMOVING THE CURTAIN. ANY SPOILS MUST BE TAKEN TO AN UPLAND AREA AND


SECTION A - A NOTE: SPILLWAY STRAW BALES, SANDBAGS OR CONTINUOUS BERM OF EQUIVALENT HEIGHT (3.6m)DIVERSION RIDGE -50' (15m) MIN. PLAN 1. THE ENTRANCE SHALL BE MAINTAINED IN A CONDITION THAT WILL PREVENT TRACKING OR FLOWING OF SEDIMENT ONTO PUBLIC RIGHT—OF—WAYS. THIS MAY REQUIRE TOP DRESSING, REPAIR AND/OR CLEAN OUT OF ANY MEASURES USED TO TRAP SEDIMENT. 2. WHEN NECESSARY, WHEELS SHALL BE CLEANED PRIOR TO ENTRANCE ONTO PUBLIC RIGHT-OF-WAY. TEMPORARY 3. WHEN WASHING IS REQUIRED, IT SHALL BE DONE ON AN AREA STABILIZED WITH CRUSHED STONE THAT DRAINS INTO AN APPROVED SEDIMENT TRAP OR SEDIMENT BASIN. GRAVEL CONSTRUCTION ENTRANCE/EXIT FILE: ENTRANCE

DIVERSION RIDGE REQUIRED WHERE GRADE EXCEEDS 2%

ROADWAY

2% OR GREATER

FILTER FABRIC

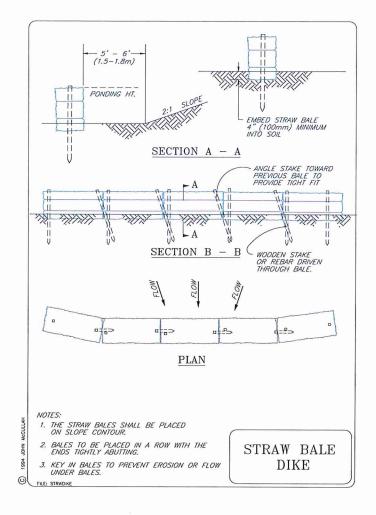

Digitally signed by Joseph C Chan 13:51:41 -04'00'

S

GROUP,

 \leq

∞

Ą,

ď

AMI, FL 33186-;

EROSION CONT PLAN, NOTES A DETAILS

NEIGHBORHOOD VETERINARIAN CLINIC 26 S.W. 4TH AVENUE

02/27/21


PROJECT NO.

18-109 SHEET NUMBER C5

리잉


Date: 2021.11.04

EROSION CONTROL PLAN NOTES AND DETAIL

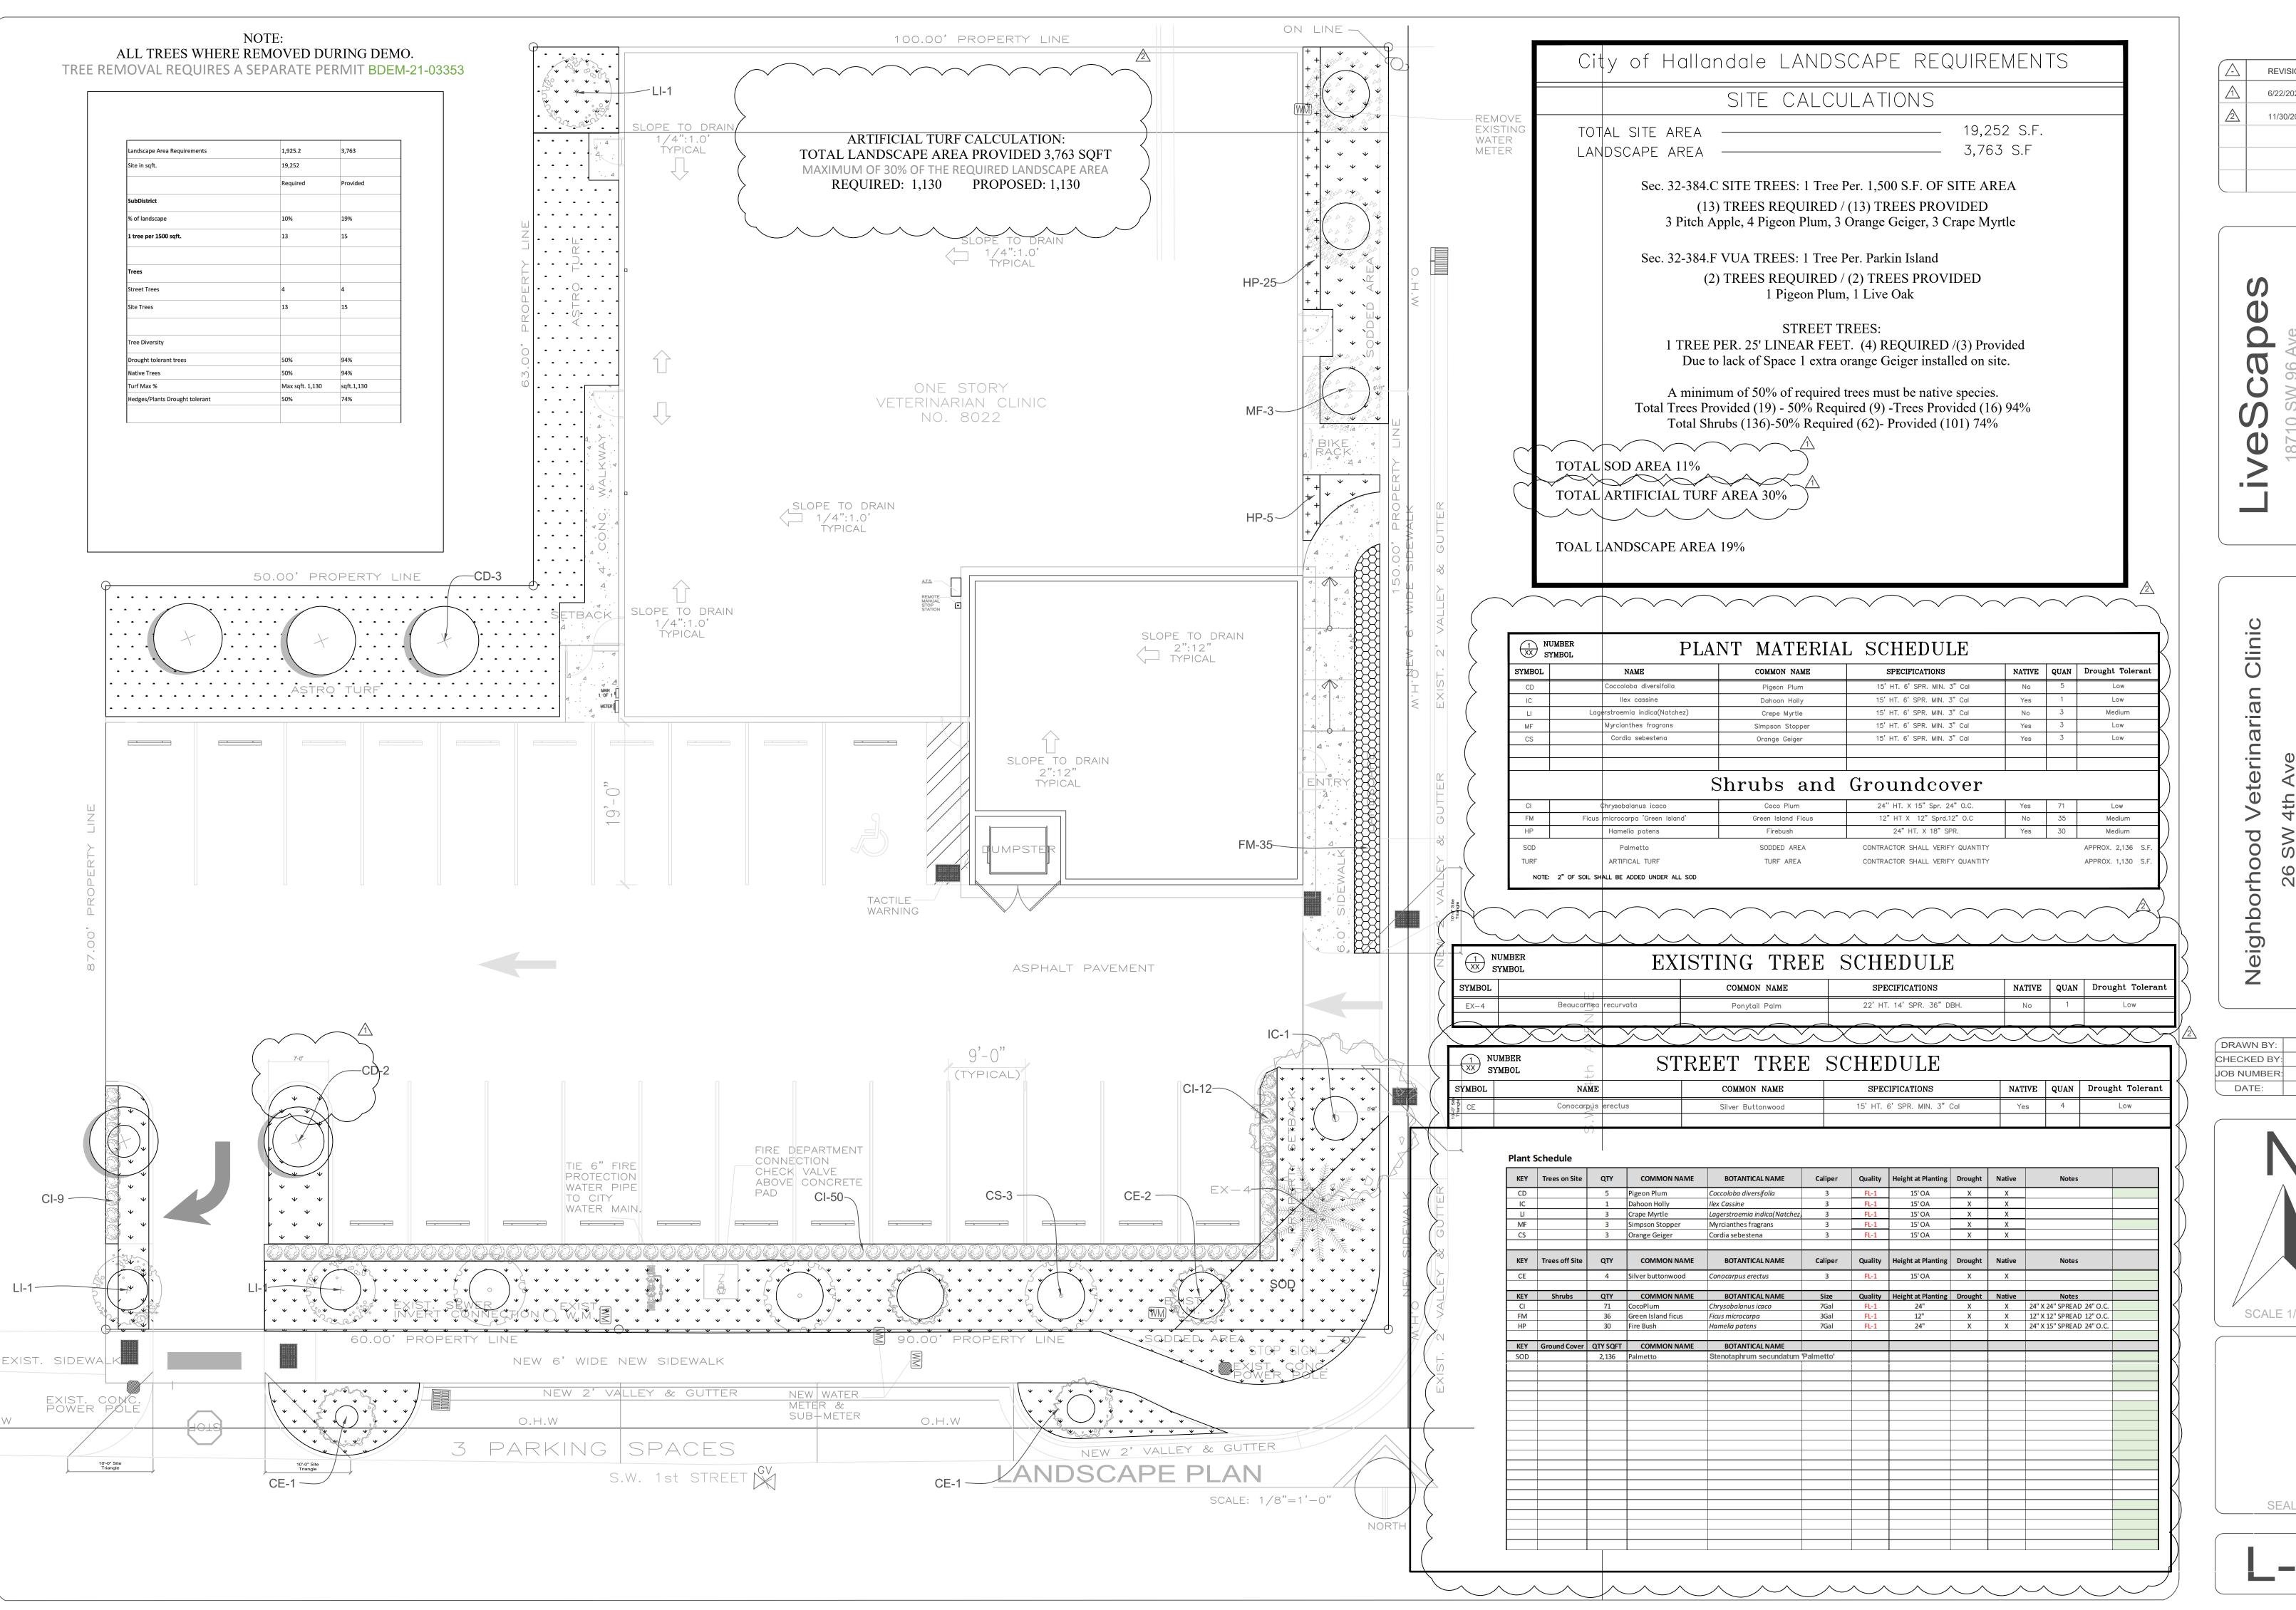

REVISION / DATE 6/22/2022 11/30/2022

JOB NUMBER: 2020-0 12/8/2022

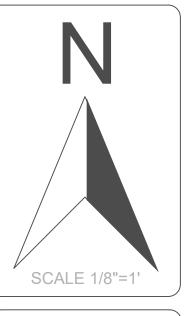

SEAL

1—All sizes shown for plant material on the plans are to be considered Minimum.

2—All plant material must meet or exceed these minimum requirements for both height and spread. Any other requirements for specific shape or effect as noted on the plan(s) will also be required for final acceptance.

3—All plant material furnished by the landscape contractor shall be Florida #1 or better as established by "Grades and Standards for Florida Nursery Plants" and "Grades and Standards for Florida Nursery Trees".

- 4—All material shall be installed as per CSI specifications. All plant material as included herein shall be warranted by the landscape contractor for a minimum period as follows: All trees and palms for 12 months, all shrubs, vines, groundcovers and miscellaneous planting materials for 90 days, and all lawn areas for 60 days after final acceptance by the owner or owner's representative.
- 5—All plant material shall be planted in planting soil that is delivered to the site in a clean loose and friable condition. All soil shall have a well—drained characteristic. Soil must be free of all rocks, sticks, and objectionable material including weeds and weed seeds as per CSI specifications. Twelve inches (12") of planting soil 50/50 sand/topsoil mix is required around and beneath the root ball of all trees and palms, and 1 cubic yard per 50 bedding or groundcover plants.

6—All landscape areas shall be covered with Eucalyptus or sterilized seed free Melaleuca mulch to a minimum depth of three inches (3") of cover when settled. Cypress bark mulch shall not be used.

7—All plant material shall be thoroughly watered in at the time of planting; no dry planting permitted. All plant materials shall be planted such that the top of the plant ball is flush with the surrounding grade.

8—All landscape and lawn areas shall be irrigated by a fully automatic sprinkler system adjusted to provide 100% coverage of all landscape areas. All heads shall be adjusted to 100% overlap as per manufacturers specifications and performance standards utilizing a rust free water source.

9—Each system shall be installed with a rain sensor.

10—It is the sole responsibility of the landscape contractor to insure that all new plantings receive adequate water during the installation and during all plant warranty periods.

11—Deep watering of all new trees and palms and any supplemental watering that may be required to augment natural rainfall and site irrigation is mandatory to insure proper plant development and shall be provided as a part of this contract.

12—All plant material shall be installed with fertilizer, which shall be State approved as a complete fertilizer containing the required minimum of trace elements in addition to N—P—K, of which 50% of the nitrogen shall be derived from an organic source as per CSI specifications.

13—Contractors are responsible for coordinating with the owners and appropriate public agencies to assist in locating and verifying all underground utilities prior to excavation.

14—All ideas, designs and plans indicated or represented by this drawing are owned by and are the exclusive property of landscape Architect

15—The plan takes precedence over the plant list.

SPECIAL INSTRUCTIONS

General site and berm grading to +/- 1 inch (1") shall be provided by the general contractor. All finished site grading and final decorative berm shaping shall be provided by the landscape contractor.

All sod areas as indicated on the planting plan shall receive Stenotaphrum secundatum, St. Augustine 'Palmetto' solid sod. It shall be the responsibility of the landscape contractor to include in the bid, the repair of any sod which may be damaged from the landscape installation operations.

TREE RELOCATION

- 1) ROOT PREPARATION
- A. Trees to be root pruned with clean, sharp equipment.
- 1. Maintain root pruned materials by watering, weeding, mowing, spraying,

fertilizing, and other horticulture practices.

2. After root pruning, backfill with good rooting medium, fertilize with organic

fertilizer to promote root growth.

3. Mulch to reduce weeds, discourage foot traffic, conserve moisture, and minimize

temperature fluctuation.

B. Root Ball Size Chart: Root ball sizes shall be according to minimum standards

set forth in Grades and Standards for Nursery Plants Part II, Palms and Trees,

Florida Department of Agriculture.

1. Trees—Minimum Ball Sizes: DBH Minimum Ball Diameter

3-1/2" to 4" 28"

4" to 4-1/2" 30"


4-1/2" to 5" 32"

5" to 5-1/2" 34"

Larger sizes increase proportionally.




NOTE: Annuals Are To Be Planted As Per Groundcover Detail Excluding Mulch.

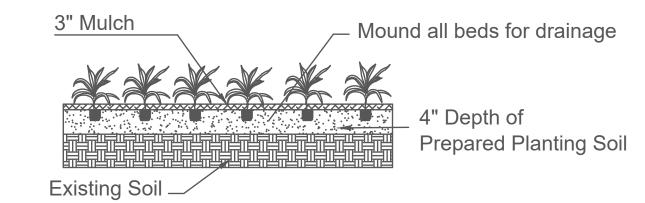


Shrub & Groundcover Planting Detail

Note: All Shrubs And Groundcover Shall Be Triangular Spaced Along Straight Edges And Will Be Planted In Parallel Rows Along


NTS

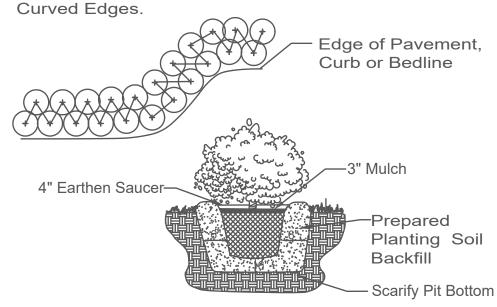

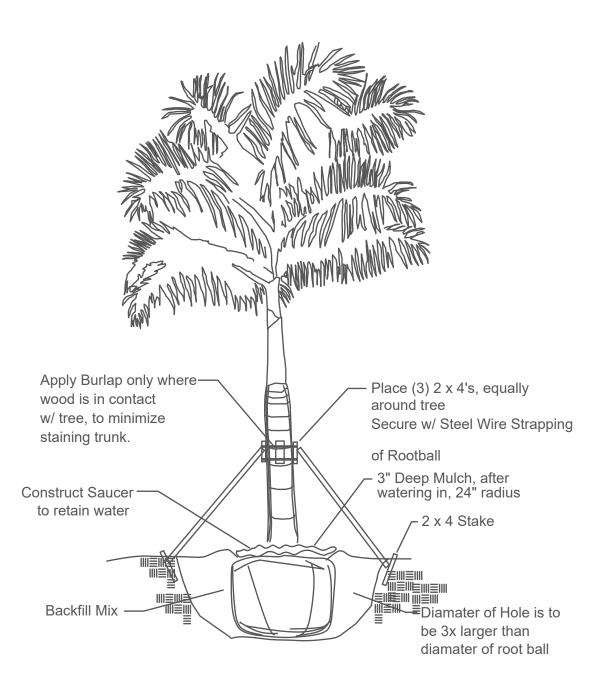

Tree Planting Detail

Tree Stakes are to be removed between 6-12 months by the Owner.

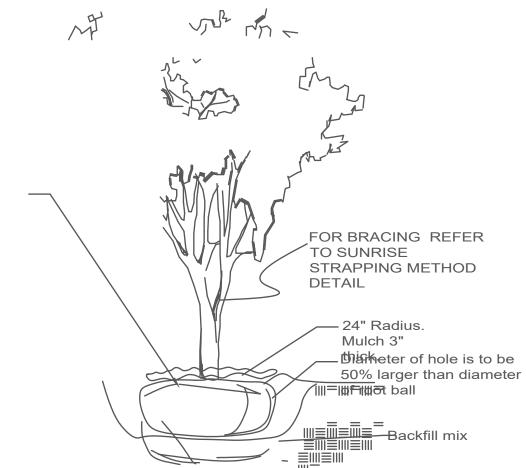

- 1. All Plants shall be Florida No.1 or better.
- 2. Landscape Contractor shall review plans and indicate any availability problems at time of bid. Landscape contractor shall be responsible bidding and installing all plantings as they are drawn on the plan, and shall verify the accuracy of the plant list vs the drawn plan, at the time of bid.
- 3. In the event that a certain specification is not able to be met, then contractor shall contact landscape architect to discuss alternatives.
- 4. Contractor shall be familiar w/ the City of Hallandale, FLORIDA landscape code and shall comply with all of its applicable requirements.
- 5. Contractor shall verify all quantities indicated at time of bid.
- 6. Contractor shall provide unit prices at time of bid.
- 7. All contractors working on the project shall be licensed and fully insured as required.
- 8. The Property Owner is responsible for replacement of all dead plant material & for maintenance of the required irrigation system.
- Tree and palm staking shall be removed between 6 and 12 months.
- 10. All prohibited exotic vegetation shall be removed from the site and it shall be maintained free of exotics in perpetuity.
- 11. The review and approval of improvement plans does not authorize the construction of required improvements which are inconsistent w/ existing easements of record.
- 12. Contractor to verify underground utilities with "Sunshine State One Call of Florida" 800-432-4770.
- 13. Contractor to verify property lines and setbacks before construction.
- 14. Contractor must have property lines staked and located, and must verify plan dimensions and field conditions are consistent.
- 15. All plant, trees, and palms shall be for guarantee 1 Year Warranty period begins at the time of project acceptance by the owner.
- 16. Irrigation Note: Per Article 9: 9.4(4): Irrigation. All landscaped areas shall receive 100% coverage by means of an automatic sprinkler system designed and constructed in accordance with the City of Hallandale Code of

Ordinances, the Florida Building Code, State Law, and the regulations of the South Florida Water Management District. Failure to maintain or disconnection of the irrigation system shall be a violation of these regulations.

- 17. Contractor shall maintain all plant material and beds must be kept weed free until accepted by owner.
- 18. Contractor shall maintain site in a clean fashion and shall remove any waste created by landscape installation construction.
- 19. All plant materials to be installed and maintained as per City of Hallandale and Broward County.
- 20. General/Site contractor shall make certain that all soil for planting areas shall be of suitable landscape quality fill. Soil shall be comprised of a sandy base, and have good organic and good percolation qualities.
- 21. General/Site contractor shall make certain all limerock and excessively compacted soils shall be removed from planting beds.
- 22. Landscape Contractor shall make certain that the site conditions meet to their satisfaction before installing plant material.
- 23. If Landscape Contractor has any concerns over the survivability of plant materials, he must inform the owner immediately.
- 24. All slopes steeper than 4:1 shall be planted with native vegetation
- 25. No Cypress Mulch is to be used on site. Eucalyptus or Melaleuca Mulch is to be used in a 3" consistent layer in all planting beds.
- 26. Landscape adjacent to vehicular traffic to be maintained to preserve sight line visibility.
- 27. This plan has been designed to meet the tree planting requirements contained within the FPL document entitled 'Plant the Right Tree in the

Right Place' and City of Hollywood Landscape Manual.

- 28. For existing or proposed utilities, no tree shall be planted where it could, at mature height conflict with overhead power lines.
- 29. Landscape adjacent to vehicular traffic to be maintained to preserve sight line visibility.

REVISION / DATE

iveScapes
18710 SW 96 Ave

Neighborhood Veterinarian Clinic 26 SW 4th Ave


DRAWN BY:

CHECKED BY:


JOB NUMBER: 2020-0

DATE: 3/10/2022



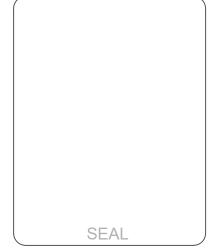

L-2

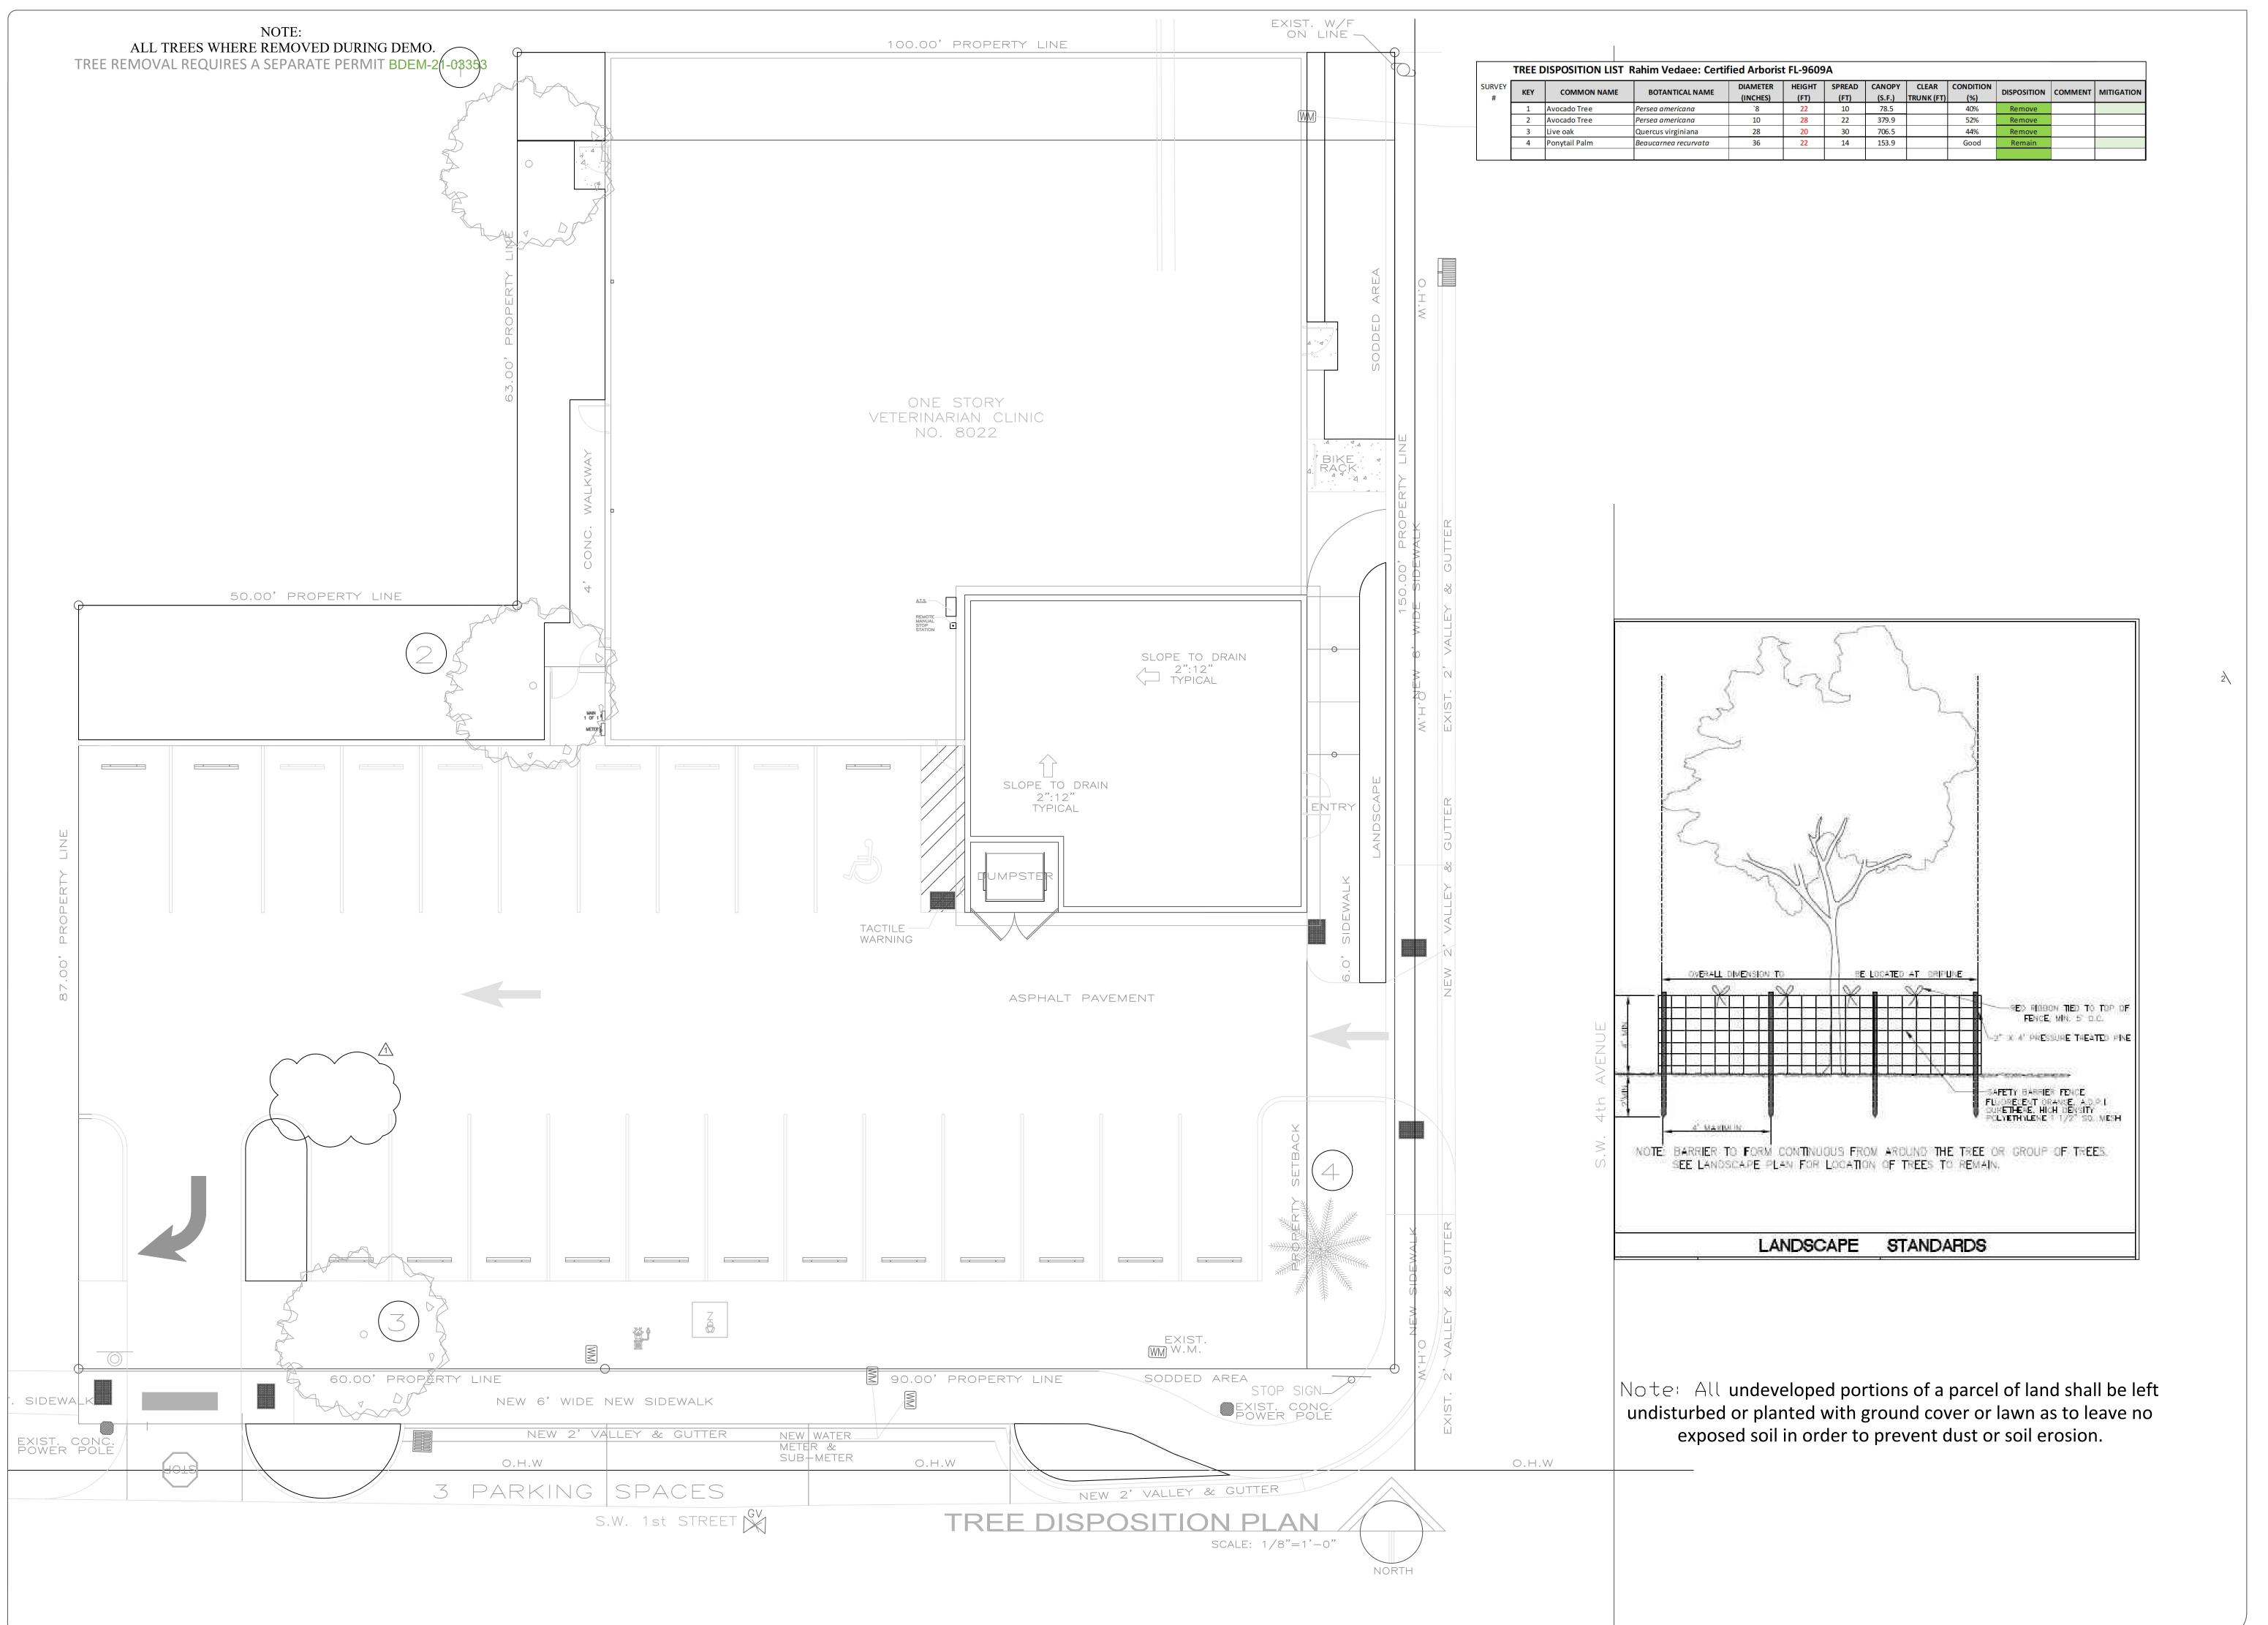

REVISION / DATE

6/22/2022

11/30/2022

VeScapes
18710 SW 96 Ave
Miami Fl 33157


Neighborhood Veterinarian Clii 26 SW 4th Ave Hallandale FL

DRAWN BY:

CHECKED BY:


JOB NUMBER: 2020-0

DATE: 12/8/2022

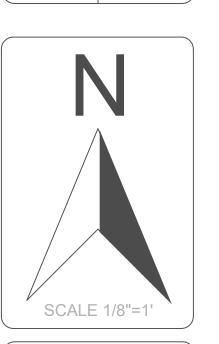



TD-1

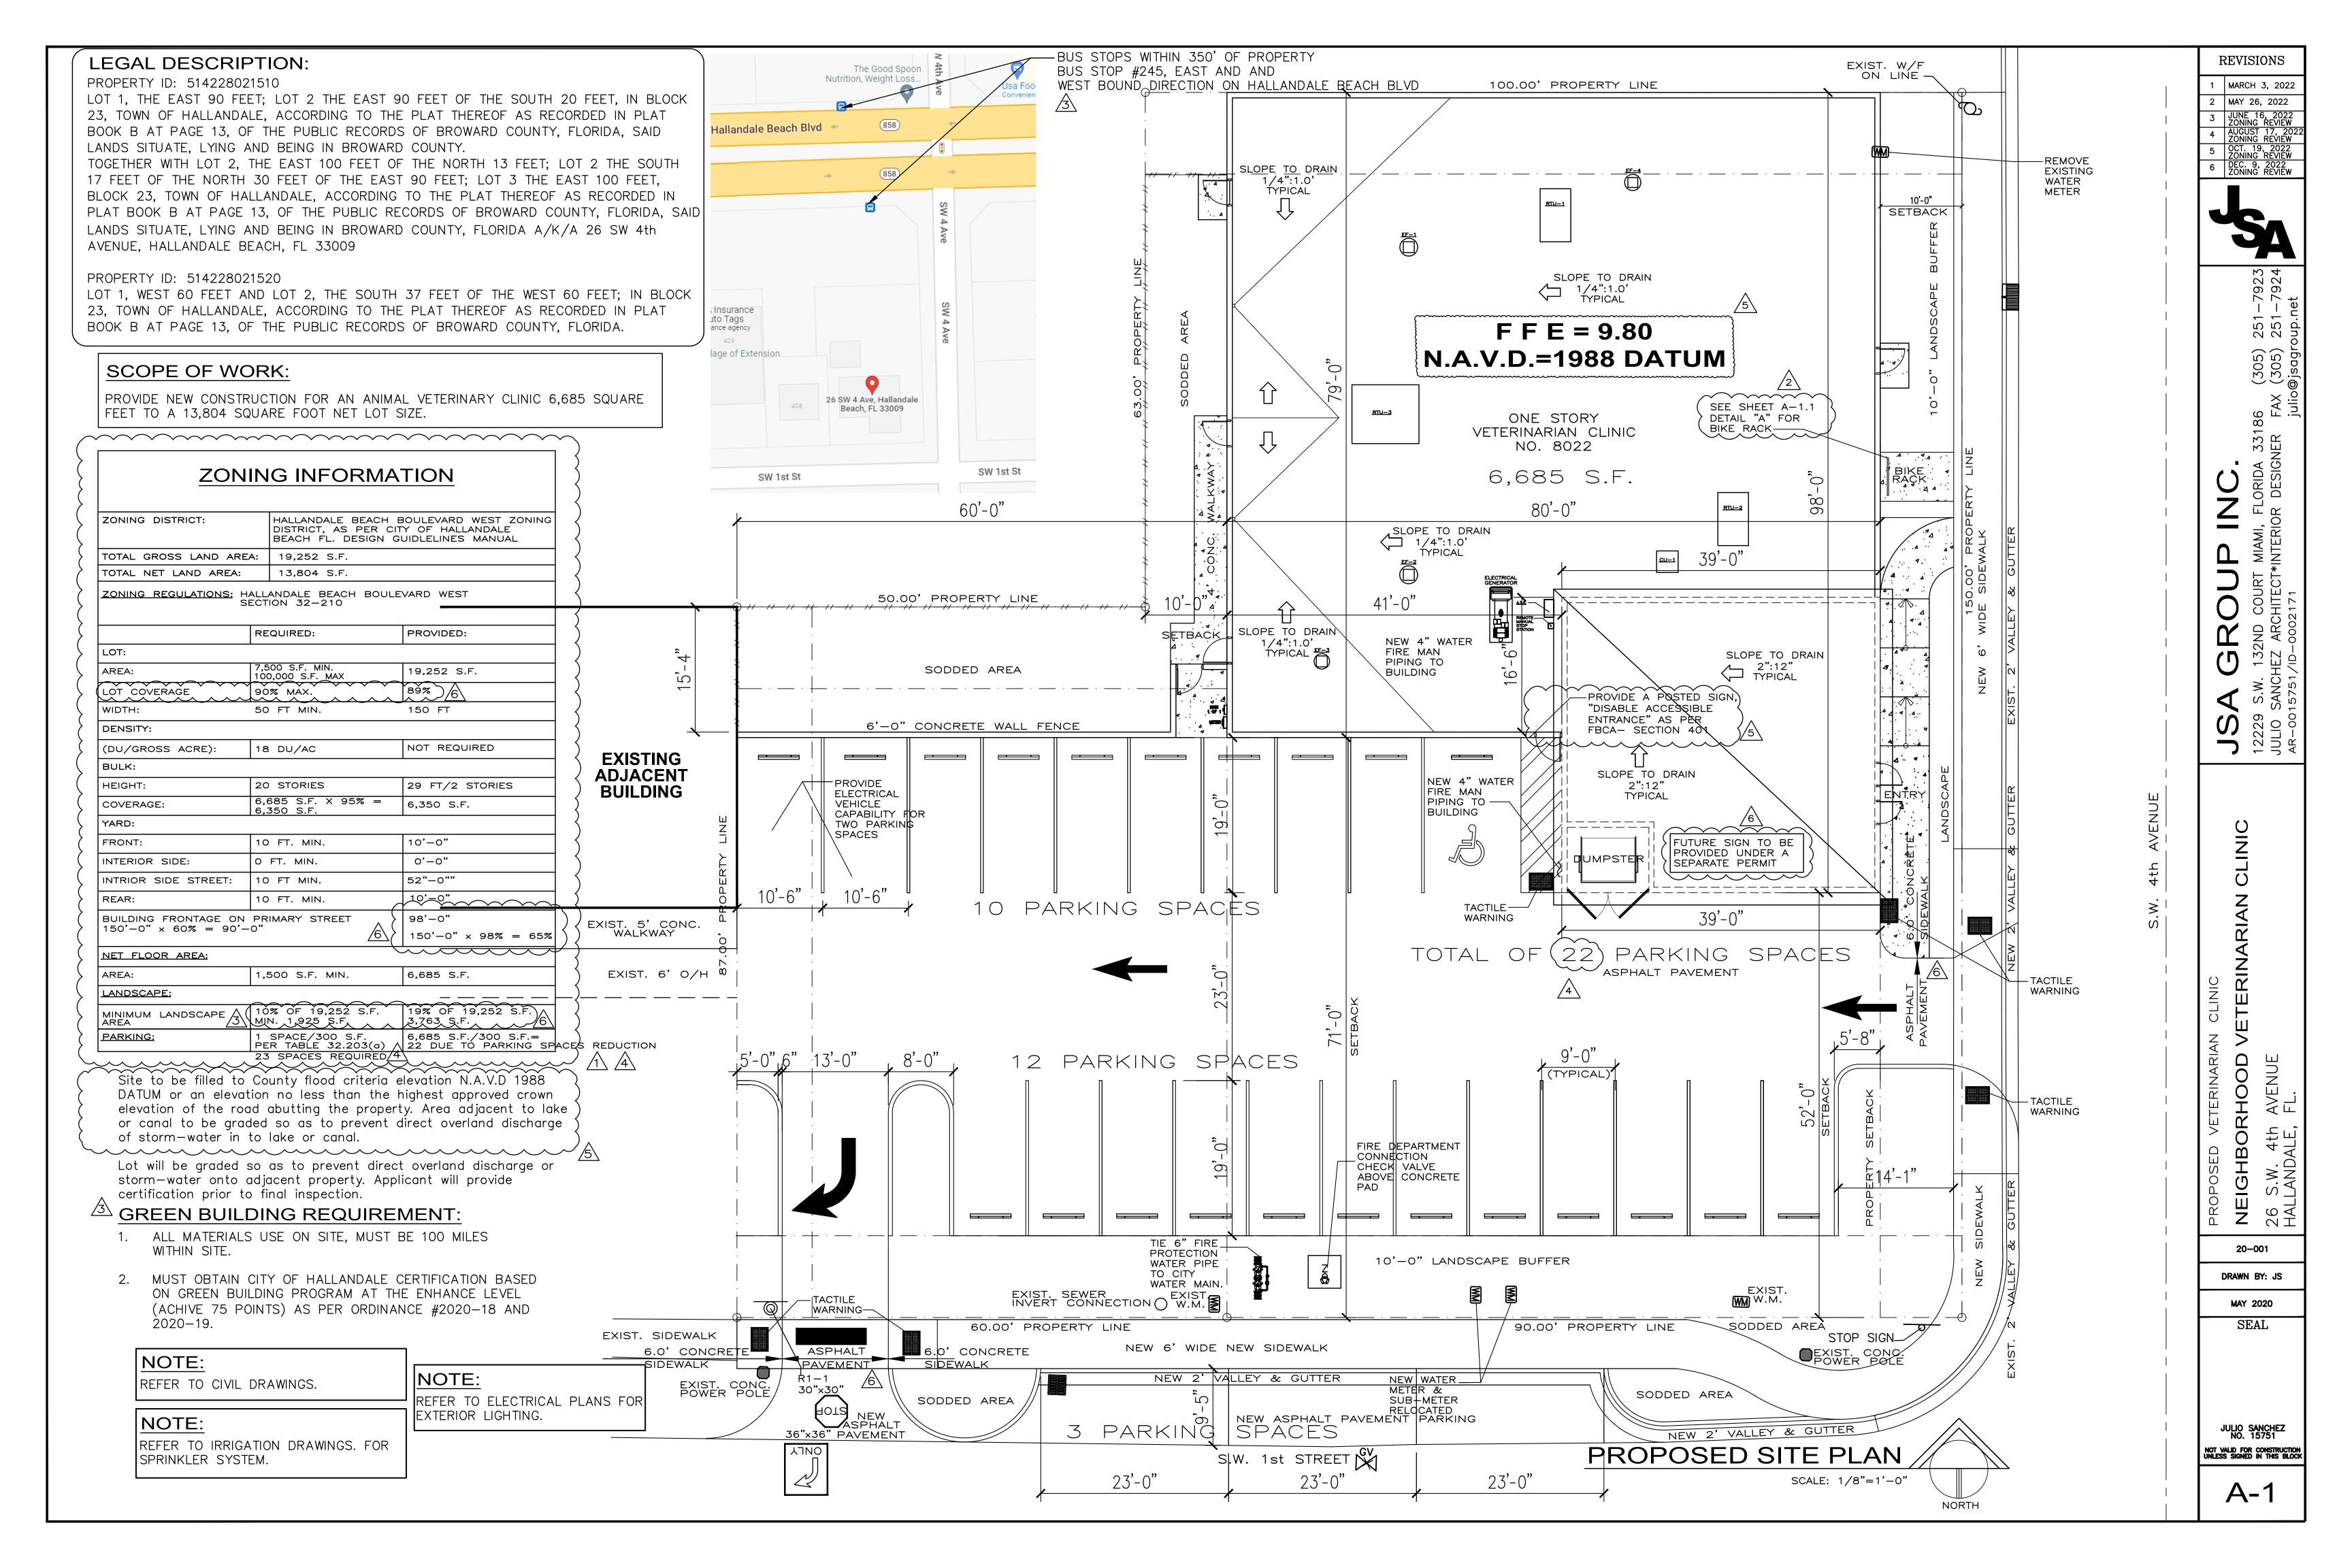

GENERAL NOTES:

- 1. ALL WORK TO BE PERFORMED SHALL COMPLY WITH THE REQUIREMENTS OF THE FLORIDA BUILDING CODE 2010. ZONING ORDINANCES APPLICABLE AND ANY AGENCY HAVING JURISDICTION ON THIS PROJECT.
- 2. MATERIALS AND/OR CONSTRUCTION SYSTEMS USED AS PART OF OR FOR THE PROTECTION OF THE ENVELOPE OF THE STRUCTURE, INCLUDING BUT NOT LIMITED TO WINDOWS, EXTERIOR GLAZING, WALL CLADDING, ROOFING, EXTERIOR DOORS, AND SHUTTERS MUST HAVE PRODUCT CONTROL ACCEPTANCE NUMBERS IN COMPLIANCE WITH THE REQUIREMENTS OF MIAMI DADE COUNTY BUILDING CODE COMPLIANCE DEPARTMENT (N.O.A., AS DEFINED IN FLORIDA BUILDING CODE 2010.
- 3. WRITTEN DIMENSIONS ON THESE DRAWINGS SHALL HAVE PRECEDENCE OVER SCALED DIMENSIONS. DO NOT SCALE DRAWINGS.
- 4. CONTRACTOR SHALL VERIFY AND BE RESPONSIBLE FOR ALL DIMENSIONS AND CONDITIONS ON THE JOB. THE ARCHITECT/ENGINEER SHALL BE NOTIFIED BEFORE PROCEEDING WITH THE WORK OF ANY DISCREPANCIES IN THE CONTRACT DOCUMENTS AND CONDITIONS ON THESE DRAWINGS AND OR ALL OBVIOUS ERRORS AND OMISSIONS
- 5. CONTRACTOR SHALL PROMPTLY NOTIFY THE ARCHITECT/ENGINEER OF THE EXISTENCE OF ANY OBSERVED VARIATIONS BETWEEN THE CONTRACT DOCUMENTS AND ANY APPLICABLE CODES OR ORDINANCES
- 6. CONTRACTOR SHALL COMPLY WITH THE FLORIDA ACCESSIBILITY CODE FOR BUILDING CONSTRUCTION (F.B.C. 2010 EDITION) AND THE AMERICAN WITH DISABILITIES ACT, PUBLIC LAW 101-336 (ADA), WHICHEVER IS MOST STRINGENT.
- 7. OWNER SHALL NOT OCCUPY PREMISES DURING CONSTRUCTION.
- A. DURING OWNER'S OCCUPANCY, IF CONTRACTOR STILL IS UNDER CONSTRUCTION WILL PROVIDE:
 - CONTINUOUS OPERATION OF HVAC AND ELECTRICAL SYSTEMS
 - SECURITY FOR/FROM CONSTRUCTION OPERATIONS AND STRORAGE. PROTECTION AND SAFETY FROM CONSTRUCTION OPERATIONS.
- TOILET FACILITIES AS REQUIRED.
- 8. ALL DRAWINGS AND DESIGNS CONTAINED HEREIN ARE THE PROPERTY OF ARCHITECT AND SHALL NOT BE REPRODUCED WITHOUT THEIR/HIS PERMISSION.
- 9. CONTRACTOR AND SUBCONTRACTORS DOING WORK ON THIS PROJECT SHALL CARRY LIABILITY AND PROPERTY DAMAGE INSURANCE AGAINST ACCIDENTS OF ALL KINDS AND THE OWNER SHALL BE FURNISHED WITH A CERTIFICATE OF SAID INSURANCE. CONTRACTOR AND ALL SUBCONTRACTORS SHALL CARRY WORKER'S COMPENSATION INSURANCE ON ALL WORKMEN EMPLOYED ON THIS JOB.
- 10. INCLUDED IN THE RESPONSIBILITIES OF ITEM 9. ARE THE FOLLOWING:
- A. EXECUTION OF ALL WORKS IN A PROPER AND SAFE MANNER FOR ALL PERSONS, EQUIPMENT AND PROPERTIES.
- B. DESIGN, ENGINEERING, CONSTRUCTION AND HANDLING OF ALL FORM WORK AND TEMPORARY STRUCTURES.
- 11. MEANS OF EGRESS SHALL COMPLY W/THE NFPA 101 2009 EDITION
- 12. WALL HUNG FIXTURES AND CABINETS SHALL BE SUPPORTED AS PER FBC 2010.
- 13. "DO NOT SCALE DRAWINGS" GENERAL CONTRACTOR SHALL VERIFY ALL PLANS, EXISTING DIMENSIONS, CONDITIONS OF THE JOB SITE AND SHALL IMMEDIATELY NOTIFY THE ARCHITECT/ENGINEER IN WRITING OF ANY DISCREPANCIES BEFORE PROCEEDING WITH THE WORK OR BE RESPONSIBLE FOR THE SAME.

SITE CONDITION NOTES:

- 1. EXISTING CONDITIONS LIKE TREES, FENCES, IRRIGATION LINES, UTILITY LINES, BUILDINGS, ETC., WERE TAKEN FROM THE BEST
- 2. CONTRACTOR SHALL VERIFY THE LOCATION OF ALL EXISTING AND PROPOSED WORK AND SHALL REPORT ANY DISCREPANCIES IN WRITING TO THE ARCHITECT/ENGINEER PRIOR TO STARTING WORK
- 3. PROPOSED CONSTRUCTION WILL BE ADJUSTED TO AVOID EXISTING TREES AND ROOTS AS MUCH AS POSSIBLE.
- 4. ANY EXISTING SOD, TREES, UTILITIES, IRRIGATION LINES, PUBLIC OR PRIVATE PROPERTY, ETC., DAMAGED DURING CONSTRUCTION SHALL BE REPAIRED, REPLACED, AND/OR RESTORED AT THE EXPENSE OF THE CONTRACTOR AS DIRECTED BY OWNER.
- 5. TREES TO BE RELOCATED SHOULD BE ROOT PRUNED 4 WEEKS MIN. BEFORE BEING TRANSPLANTED.(IF APPLICABLE)
- 6. PROVIDE MINIMUM 2" TOPSOIL FOR FINAL GRADING, RAKE AND REMOVE ROCKS IN EXCESS OF 1/2" AND INSTALL A MINIMUM OF 10' WIDE SOD AROUND PERIMETER OF NEW FINISHED BUILDING(S), WITH A 6 TO 1 MAXIMUM SLOPE. REPLACE ANY PORTIONS DAMAGED DURING CONSTRUCTION AS REQUIRED.
- 7. TRENCHES: FILL UP TO GRADE WITH SUITABLE MATERIAL AND COMPACT, RAKE & REMOVE ROCKS IN EXCESS OF 1/2 INCHES, LAST 2 INCHES MUST BE A 50/50 MIXTURE OF TOP SOIL & SAND TO PROMOTE GRASS GROWING. (IF APPLICABLE)
- 8. ALL ORGANIC MATERIAL REMOVED PER STRUCTURAL SPECS SHALL BE STORED ELSEWHERE TO BE REUSED FOR GRADING.
- 9. MAINTAIN BUILDING SITE CLEAN OF CONSTRUCTION DEBRIS THROUGH THE DURATION OF THE PROJECT.

BURGLARY INTRUSION NOTES

- 1. ALL LOCKS ON EXTERIOR DOORS SHALL BE CAPABLE OF RESISTING A FORCE OF 300 LBS. APPLIED IN ANY MOVABLE DIRECTION.
- 2. ALL SINGLE EXTERIOR SWING DOORS SHALL HAVE A LOCK TO BE KEY OPERATED FROM THE EXTERIOR WITH A MINIMUM OF 6,000 POSSIBLE KEY CHANGES OR LOCKING COMBINATIONS. IF KEY-IN-KNOB LOCK IS USED, THERE SHALL BE AN AUXILIARY SINGLE DEAD BOLT WITH HARDENED BOLT OR INSERTS.
- 3. THE ACTIVE LEAF OF PAIRS OF EXTERIOR SWING DOORS SHALL HAVE SAME LOCKS AS REQUIRED FOR SINGLE EXTERIOR SWING DOORS. THE INACTIVE LEAF OF THESE PAIR OF DOORS SHALL HAVE MULTIPLE POINT LOCKS WITH " MINIMUM THROW BOLTS WITH INSERTS.
- 4. SLIDING GLASS DOORS SHALL BE PROVIDED WITH SLIDING DOOR DEADBOLT OR A PIN NOT REMOVABLE OR OPERABLE FROM THE EXTERIOR AT THE JAMB. SILL. HEAD OR MEETING MULLIONS. THESE DOORS SHALL BE REINFORCED IN THE STRIKE AND LOCK AREA TO MAINTAIN BOLT STRENGTH EFFECTIVENESS IF NECESSARY AND SUCH DOORS SHALL HAVE READY ENTRY FROM OUTSIDE.
- 5. OVERHEAD DOORS SHALL BE PROVIDED WITH MULTIPLE POINT LOCKS OR BE LOCKED AT MORE THAN ONE POINT WITH HARDENED BOLT OR BOLTS WITH INSERTS ENGAGING AT LEAST TWO OPPOSITE POINTS A MINIMUM OF ". OTHER LOCKING DEVICES SHALL NOT BE REQUIRED WHERE SUCH DOORS ARE CONTROLLED AND LOCKED BY ELECTRIC POWER.
- HINGES ON EXTERIOR OUT SWINGING DOORS SHALL HAVE NON-EXPOSED SCREWS AND NON-OPERABLE PINS.
- 7. JAMBS OF ALL EXTERIOR OFFSET TYPE IN-SWINGING DOORS SHALL BE RABBETTED OR OF SIMILAR FABRICATION TO PREVENT DEFEATING THE PURPOSE OF THE STRIKE AND THE INTEGRITY OF LOCKS AND LATCHES.
- SINGLE SWING EXTERIOR DOORS, IF WOOD, SHALL BE SOLID CORE OF NOT LESS THAN 1— "IN THICKNESS.
- 9. GLASS IN EXTERIOR DOORS SHALL COMPLY WITH THE AMERICAN NATIONAL STANDARDS INSTITUTES, STANDARD Z97.1.
- 10. VISION PANELS IN EXTERIOR DOORS, OTHER THAN GLAZING WITHIN DOORS, SHALL COMPLY WITH AMERICAN NATIONAL STANDARDS INSTITUTE, STANDARD Z97.1.
- 11. SLIDING GLASS DOORS AND WINDOWS SHALL BE INSTALLED AND CONSTRUCTED SO THAT NO PANEL CAN BE LIFTED FROM THE TRACKS WHEN IN THE LOCKED POSITION AND SO AS TO COMPLY WITH THE ARCHITECTURAL ALUMINUM MANUFACTURERS ASSOCIATION STANDARD FOR FORCED ENTRY RESISTANCE, AAMA 13303.3.
- 12. VENTS IN OVERHEAD GARAGE TYPE DOORS SHALL NOT BE INSTALLED CLOSER THAT 40" TO THE INSIDE LOCK ACTIVATING DEVICE.
- 13. SINGLE SWING EXTERIOR AND SWING DOORS CONNECTING LIVING AREAS WITH GARAGE AREAS SHALL BE SECURED WITH A LATCH AND A SINGLE DEAD BOLT WITH ONE INCH MINIMUM THROW OR A COMBINATION OF DEAD LATCH AND DEAD BOLT SETS WITH A LATCH THROW A MINIMUM OF «" AND BOLTS HAVING A 1"MINIMUM THROW. DOORS SHALL BE A MINIMUM OF 1- " THICK.
- 14. FRONT MAIN ENTRANCE DOORS SHALL BE PROVIDED WITH A SCOPE OR VISION PANELS.

OCCUPANCY LOAD CALCULATION

CLASSIFICATION AS PER CHAPTER 3 OF F.B.C 2020 BUSINESS GROUP B

AS PER TABLE 1004.1.1, BUSINESS AREAS, & NFPA 2021 TABLE 7.3.1.2

FIRST FLOOR AREA 150 SQ-FT GROSS/ OCCUPANT 6,416 SQ-FT / 100 = 43 PERSONS

SECOND FLOOR AREA 150 SQ-FT GROSS/ OCCUPANT 269 SQ-FT/100 = 2 PERSONS(STORAGE AREA ONLY)

CONSTRUCTION TYPE

TYPE III B

AS PER F.B.C. 2020 BUILDING, SECTION 602.3

PLUMBING FIXTURES REQ'MT

FIRST FLOOR AREA TOTAL PERSONS - 45 OCCUPANTS/2 = 22.5 PER GENDER PLUMBING FACILITIES REQUIRED:

1 WC & LAV. AS PER PLUMBING TABLE 403.1 1 DRINKING FOUNTAIN

DESIGN DATA

FLORIDA BUILDING CODE 2020 OCCUPANCY GROUP "B" (AS PER SECTION 305.1) TYPE: II-A (AS PER TABLE 601) BUILDING COMPLIES WITH FBC 2020, TABLE 503 TYPE IIIA ALLOWABLE HEIGHT AND TABLE 601 FIRE RESISTANCE RATING

REQUIREMENTS.

DEFFERRED SUBMITTALS OF SHOP DRAWINGS-FBC107.3.4.1

- 1. FIRE ALARM SYSTEM SUBMITTAL
- 2. FIRE PROTECTION SYSTEM SUBMITTAL(SPRINKLERS) WET SYSTEM
- 3. HYDRAULIC CALCULATION FOR FIRE PROTECTIONS SYSTEM
- 4. FIRE ALARM SYSTEM CUT SHEETS SPECIFICATIONS
- 5. WEB STEEL FOR ROOFING FRAMING SYSTEM
- 6. NOA'S FOR EXTERIOR DOORS
- 7. NOA'S FOR WINDOWS
- 8. NOA'S FOR HVAC MOUNTING SYSTEM WITH STRUCTURAL CALCULATIONS
- 9. PANIC HARDWARE FOR EXTERIOR DOORS
- 10. WIND RESISTANT FOR STRUCTURE TIE DOWNS

APPLICABLE CODES:

	<u>ABBREV.</u>	<u>Definition</u>	<u>Editions</u>
_	FBC	FLORIDA BUILDING CODE	2020
	FFPC	FLORIDA FIRE PROTECTION CODE	2020
^	MEPA	-NFPA-101~LIFE-SAFETY-CODE	~2017~~~~
	ADA	AMERICANS WITH DISABILITIES ACT	2010
	FAC	FLORIDA ACCESIBILITY CODE	2020

BUILDING DATA

BUILDING CLASSIFICATION

TYPE III-B (AS PER TABLE 601)

HEIGHT - LOW-RISE AREA - 6,685 SF

BIKE RACK DETAIL

SCALE: 3/4" = 1'-0"

COLONNADE

ENTRY

, CIRCLÉ BIKE RACK 10-GAUGE, GALVANIZED STEEL (2 BIKE CAPACITY)

CODE OF ORDINACE CITY OF

OF HALLANDALE BEACH, FLORIDA

PORCH STOOP BRACKETED FORECOURT STOREFRONT

BALCONY

FRONTAGE TYPE

AS PER TABLE 32-201(a)

RAC SUBDISTRICT

RAC SUBDISTRICT

FRONTAGE TYPES PER SUBDISTRICT

OCCUPANCY PER CHAPTER 3 - FBC 2020 BUSINESS GROUP "B", CLINIC OUTPATIENT.

OCCUPANCY PER CHAPTER 3 - FBC 2020

TYPE OF WORK/NFPA 101 CHAPTER 43 X MODIFICATION

BUILDING SHALL COMPLY WITH FBC 2020, TABLE 803.5 & 804 INTERIOR WALLS AND CEILING FINISH REQUIREMENTS:

ASSEMBLY GROUP "A", AS PER SECTION 303.1.2

1- CLASS "B" FOR VERTICAL EXITS AND EXIT PASSAGEWAYS 2- CLASS "C" FOR EXIT ACCESS CORRIDORS AND OTHER EXITWAYS, ROOMS AND ENCLOSED SPACES.

OCCUPANCY LOAD CALCULATION

CLASSIFICATION AS PER CHAPTER 3 OF F.B.C (2020) BUSINESS GROUP "B", CLINIC OUTPATIENT.

AS PER TABLE 1004.1.2, FBC (2020), BUSINESS AREAS, & NFPA 101, 2021 TABLE 7.3.1.2

BUSINESS USE: TOTAL BUILDING AREA

6,685 SF OCCUPANT LOAD FACTOR ÷ 150 SF/PERSON

OCCUPANT CAPACITY 45 PERSONS

FLOOR AREA CALCULATION

EXISTING BUILDING:

TOTAL SQUARE FEET:

FIRST FLOOR AREA 6,416 SQ-FT SECOND FLOOR AREA 269 SQ-FT

City of Hallandale Beach, Florida Flood Legend

26 S.W. 4th AVENUE/408 S.W. 1st STREET ADDRESS: HALLANDALE BEACH, FLA. 33009 ID. 514228021510/514228021520

__ PLS Lic #: <u>6220</u>

Highest Crown of Road Elevation: 8.28 Highest Crown of Road Elevationabove was taken from a certified survey prepare by:

Surveyor's Name CTY FLOOD CRITERIA: ZONE-X

PLAT BOOK: JUAN A. SUAREZ

CROWN OF ROAD- 9.04'

6,685 SQ-FT

UNDERGROUND PARKING: YES/(NO) (CIRCLE ONE)

BASEMENT: YES (NO) (CIRCLE ONE)

	Lowest Floor Elev.	Adjacent	Grade Elevation	Catch	Basin Elevation	Retention Area
PROPOSED	9.80 FT. NGVD	8.90'	FT. NGVD	9.0	FT. NGVD	N/A

SITE TO BE FILLED TO COUNTY FLOOD CRITERIA ELEVATION N.G.V.D. OR AN ELEVATION NO LESS THAN THE HIGHEST APPROVED CROWN ELEVATION OF THE ROAD ABUTTING THE PROPERT AREA ADJACENT TO LAKE OR CANAL TO BE GRADED SO AS TO PREVENT DIRECT OVERLAND DISCHARGE OF STORMWATER INTO LAKE LOT WILL BE GRADED SO AS TO PREVENT DIRECT OVERLAND DISCHARGE OF STORMWATER ONTO ADJACENT PROPERTY.
APPLICANT WILL PROVIDE CERTIFICATION PRIOR TO FINAL INSPECTION.

IN ADDITION TO THE REQUIREMENTS OF THIS PERMIT THERE MAY BE ADDITIONAL RESTRICTIONS APPLICABLE TO THIS PROPERTY THAT MAY BE FOUND IN THE PUBLIC RECORDS OF BROWARD COUNTY.

WILL COMPLY WITH CITY OF HALLANDALE BEACH FLOOD PLAIN ORDINANCE: #2016-15 EFF. 8/17//2016.

A SEPERATE PERMIT WILL BE REQUIRED FOR ALL DRIVEWAY APPROACHES ONTO PUBLIC RIGHT OF WAY. CONTACT PUBLIC WORKS DEPT. COMPLY WITH FBC(BCAP)117.2 & ASCE24

REVISIONS

<u>1\</u> |08-06-2021

05-26-2022

08-17-2022

7923 7924 51.

305) 9

DRAWN BY: JS MAY 2021 SEAL

20-001

JULIO SANCHEZ

A-1.1

FIRE EXTINGUISHER, SURFACE MOUNTED

FIRE EXTINGUISHER CABINET-RECESSED

SEMI-RECESSED-FIRE RATED PER SPEC

DENOTES FIRE EXTINGUSHER TYPE

FIRE EXTINGUISHER CABINET-

SECTION 10522

FIRE EXTINGUISHER CABINET-RECESSED-1

EXTINGUSHERS

WORK COMPLETED AND UNDAMAGED.

11. COORDINATION WITH OWNER:

10.2.1 PRIOR TO ACCEPTANCE OF THE WORK BY THE OWNER, ALL DAMAGE TO EXISTING AND NEW STRUCTURES,

10.4 THE CONTRACTOR SHALL PROVIDE A "SAFETY PLAN" WHICH DELINEATES AREAS OF CONSTRUCTION AND

ACCESS, AND SPECIAL REQUIREMENTS WHICH MAY BE REQUIRED BY THE OWNER.

11.2 COORDINATE WITH BUILDING OCCUPANTS/ADMINISTRATION TO ENSURE MINIMAL DISRUPTION TO STAFF.

DETECTION AND WARNING SYSTEMS IN USE WHILE PARK IS OCCUPIED.

GROUNDS, UTILITIES, ETC. AND/OR WORK PERFORMED BY OTHERS WHICH, IN THE OPINION OF THE A/E, IS

10.3 THE CONTRACTOR SHALL FIELD VERIFY ALL EXISTING CONDITIONS. PRIOR TO COMMENCEMENT OF THE WORK, ALL

DISCREPANCIES SHALL BE BROUGHT TO THE ATTENTION OF THE ARCHITECT/ENGINEER BY THE CONTRACTOR.

CONSTRUCTION TRAFFIC DURING PHASES OF THE PROJECT, MAINTAINS REQUIRED EXITS, AND PROVIDES FOR

10.5 COORDINATE PROPOSED DEMOLITION ITEMS WITH THE ASBESTOS DEPARTMENT IN ORDER TO AVOID CONSTRUCTION

THE CONTRACTOR SHALL BE RESPONSIBLE FOR COORDINATION WITH THE THE OWNER REGARDING SCHEDULING,

BARRIERS TO SEPARATE CONSTRUCTION AREAS FROM STAFF. THE PLAN MUST PROVIDE FOR MAINTAINING FIRE

ATTRIBUTABLE TO THE CONTRACTOR, SHALL BE REPAIRED OR REPLACED BY THE CONTRACTOR, AT NO ADDITIONAL

REVISIONS



9

Z % ±

20-001


DRAWN BY: JS


MAY 2021

SEAL

JULIO SANCHEZ NO. 15751

A-1.2

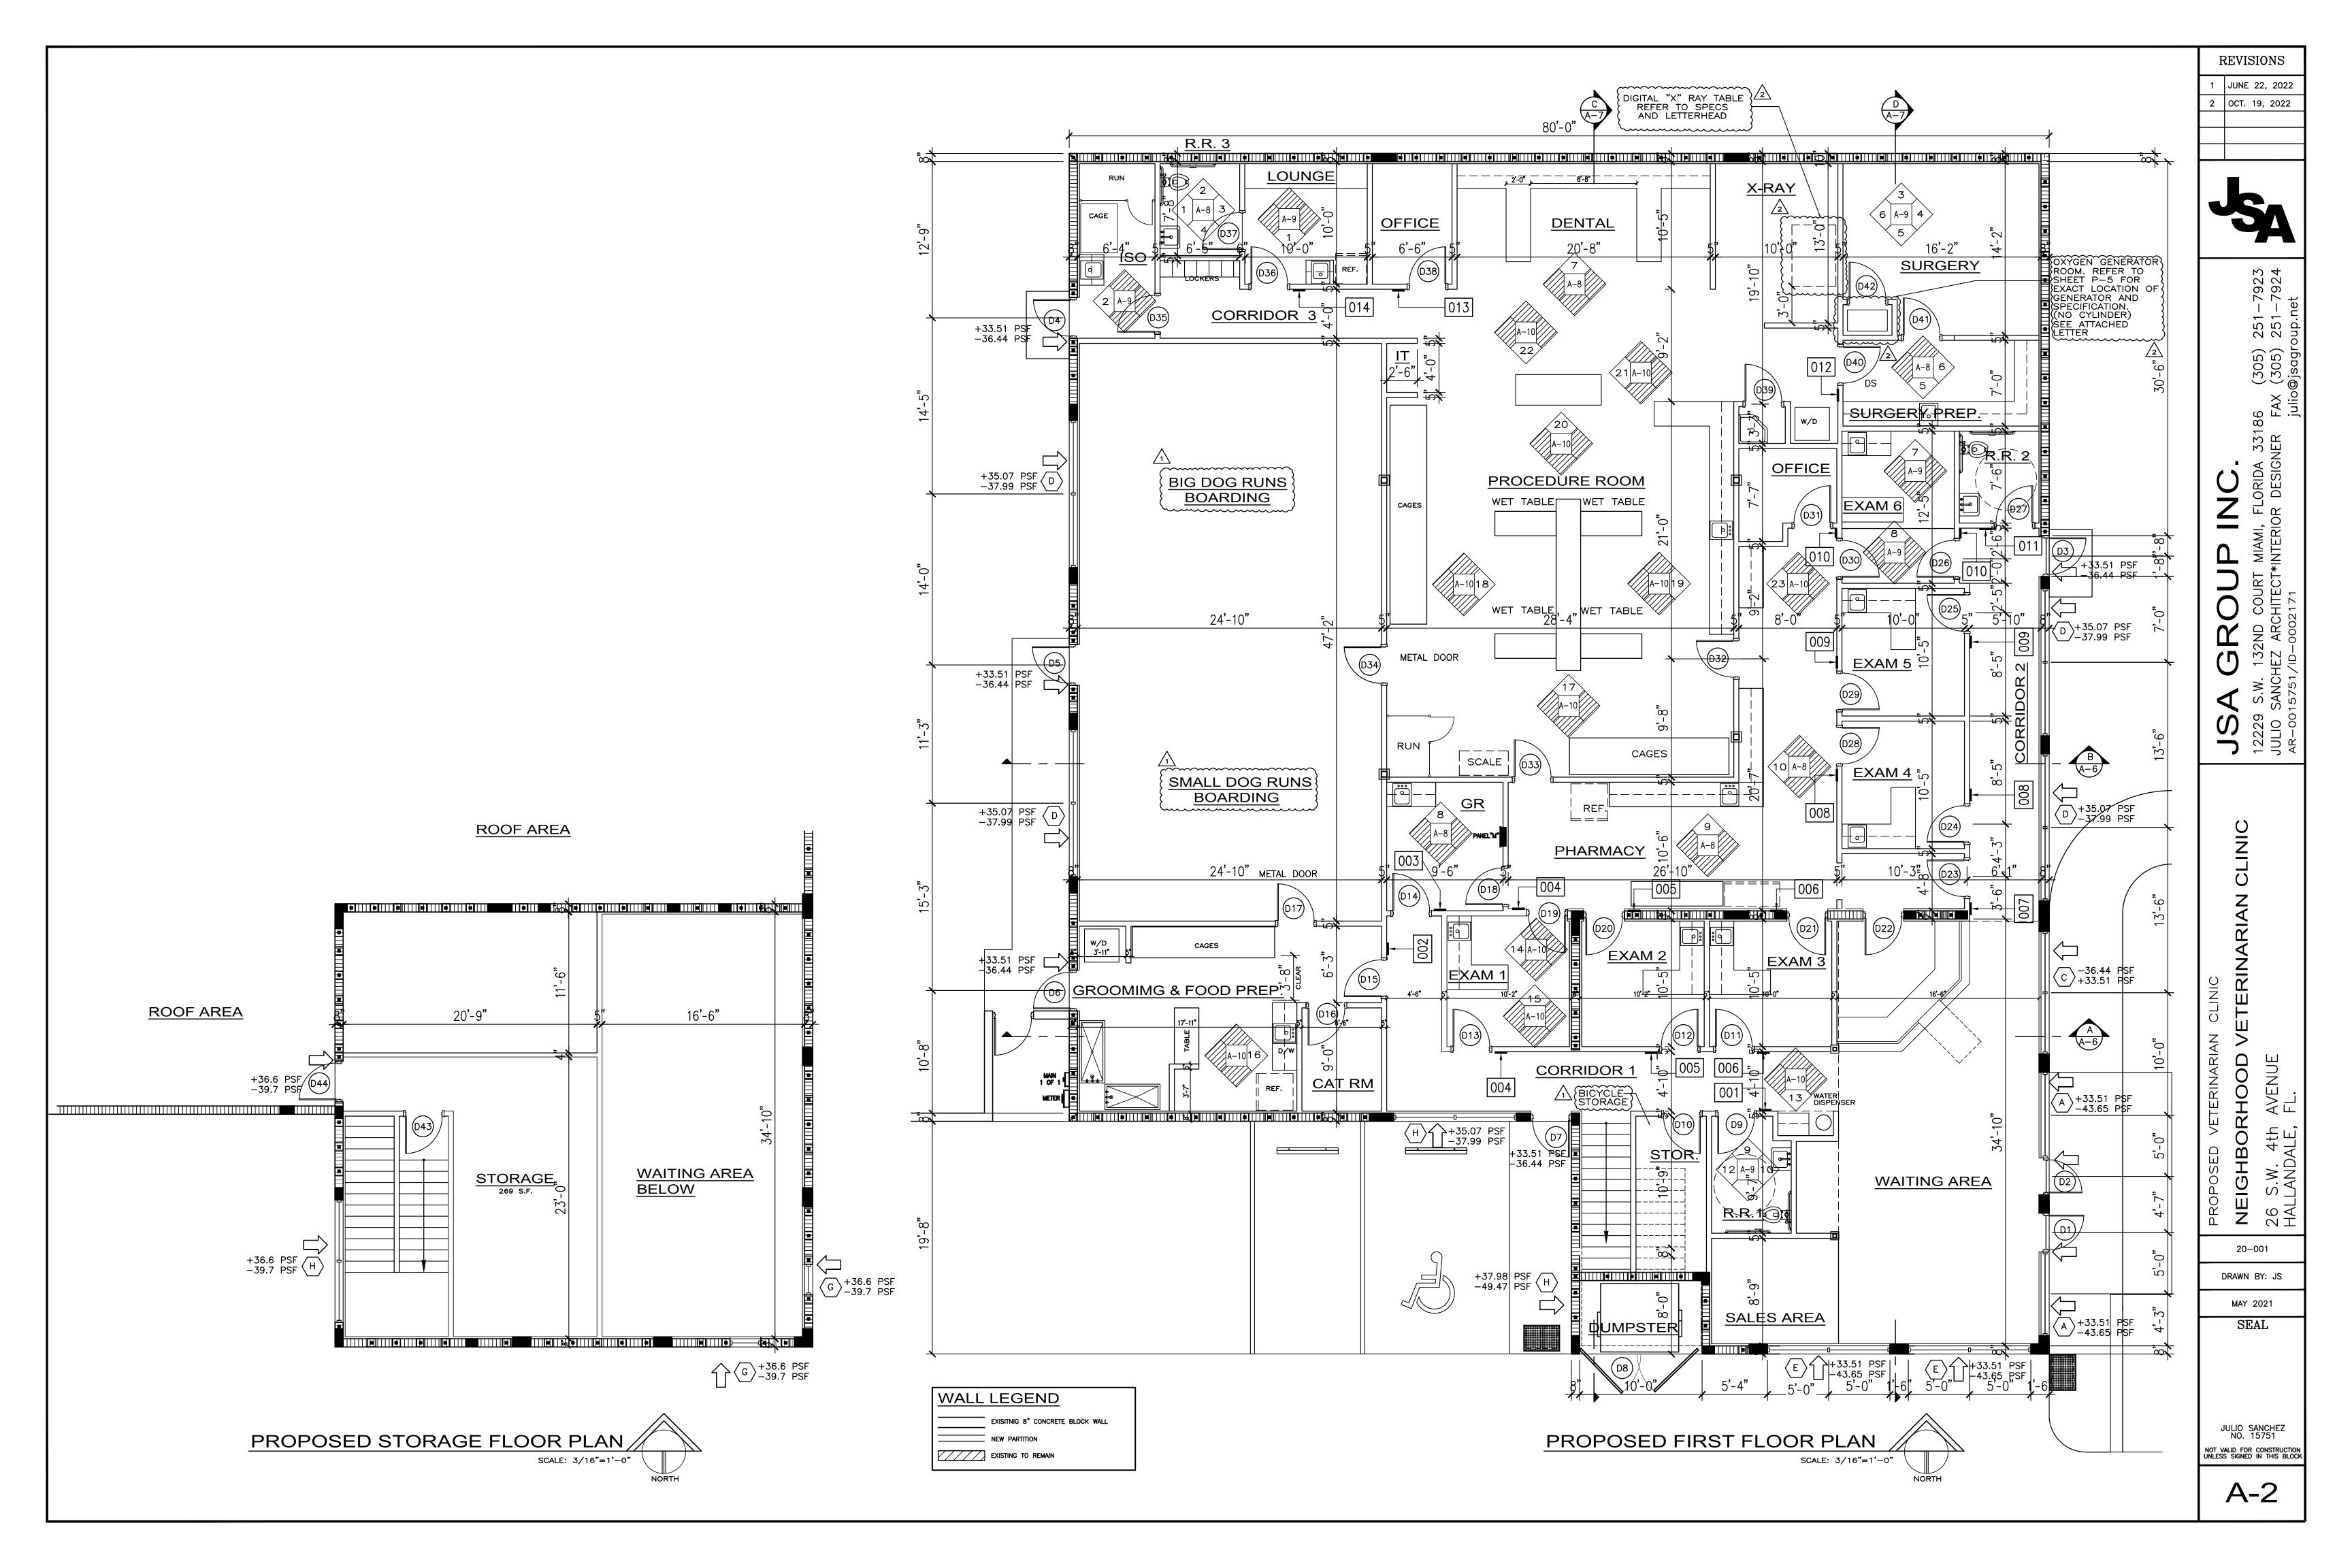

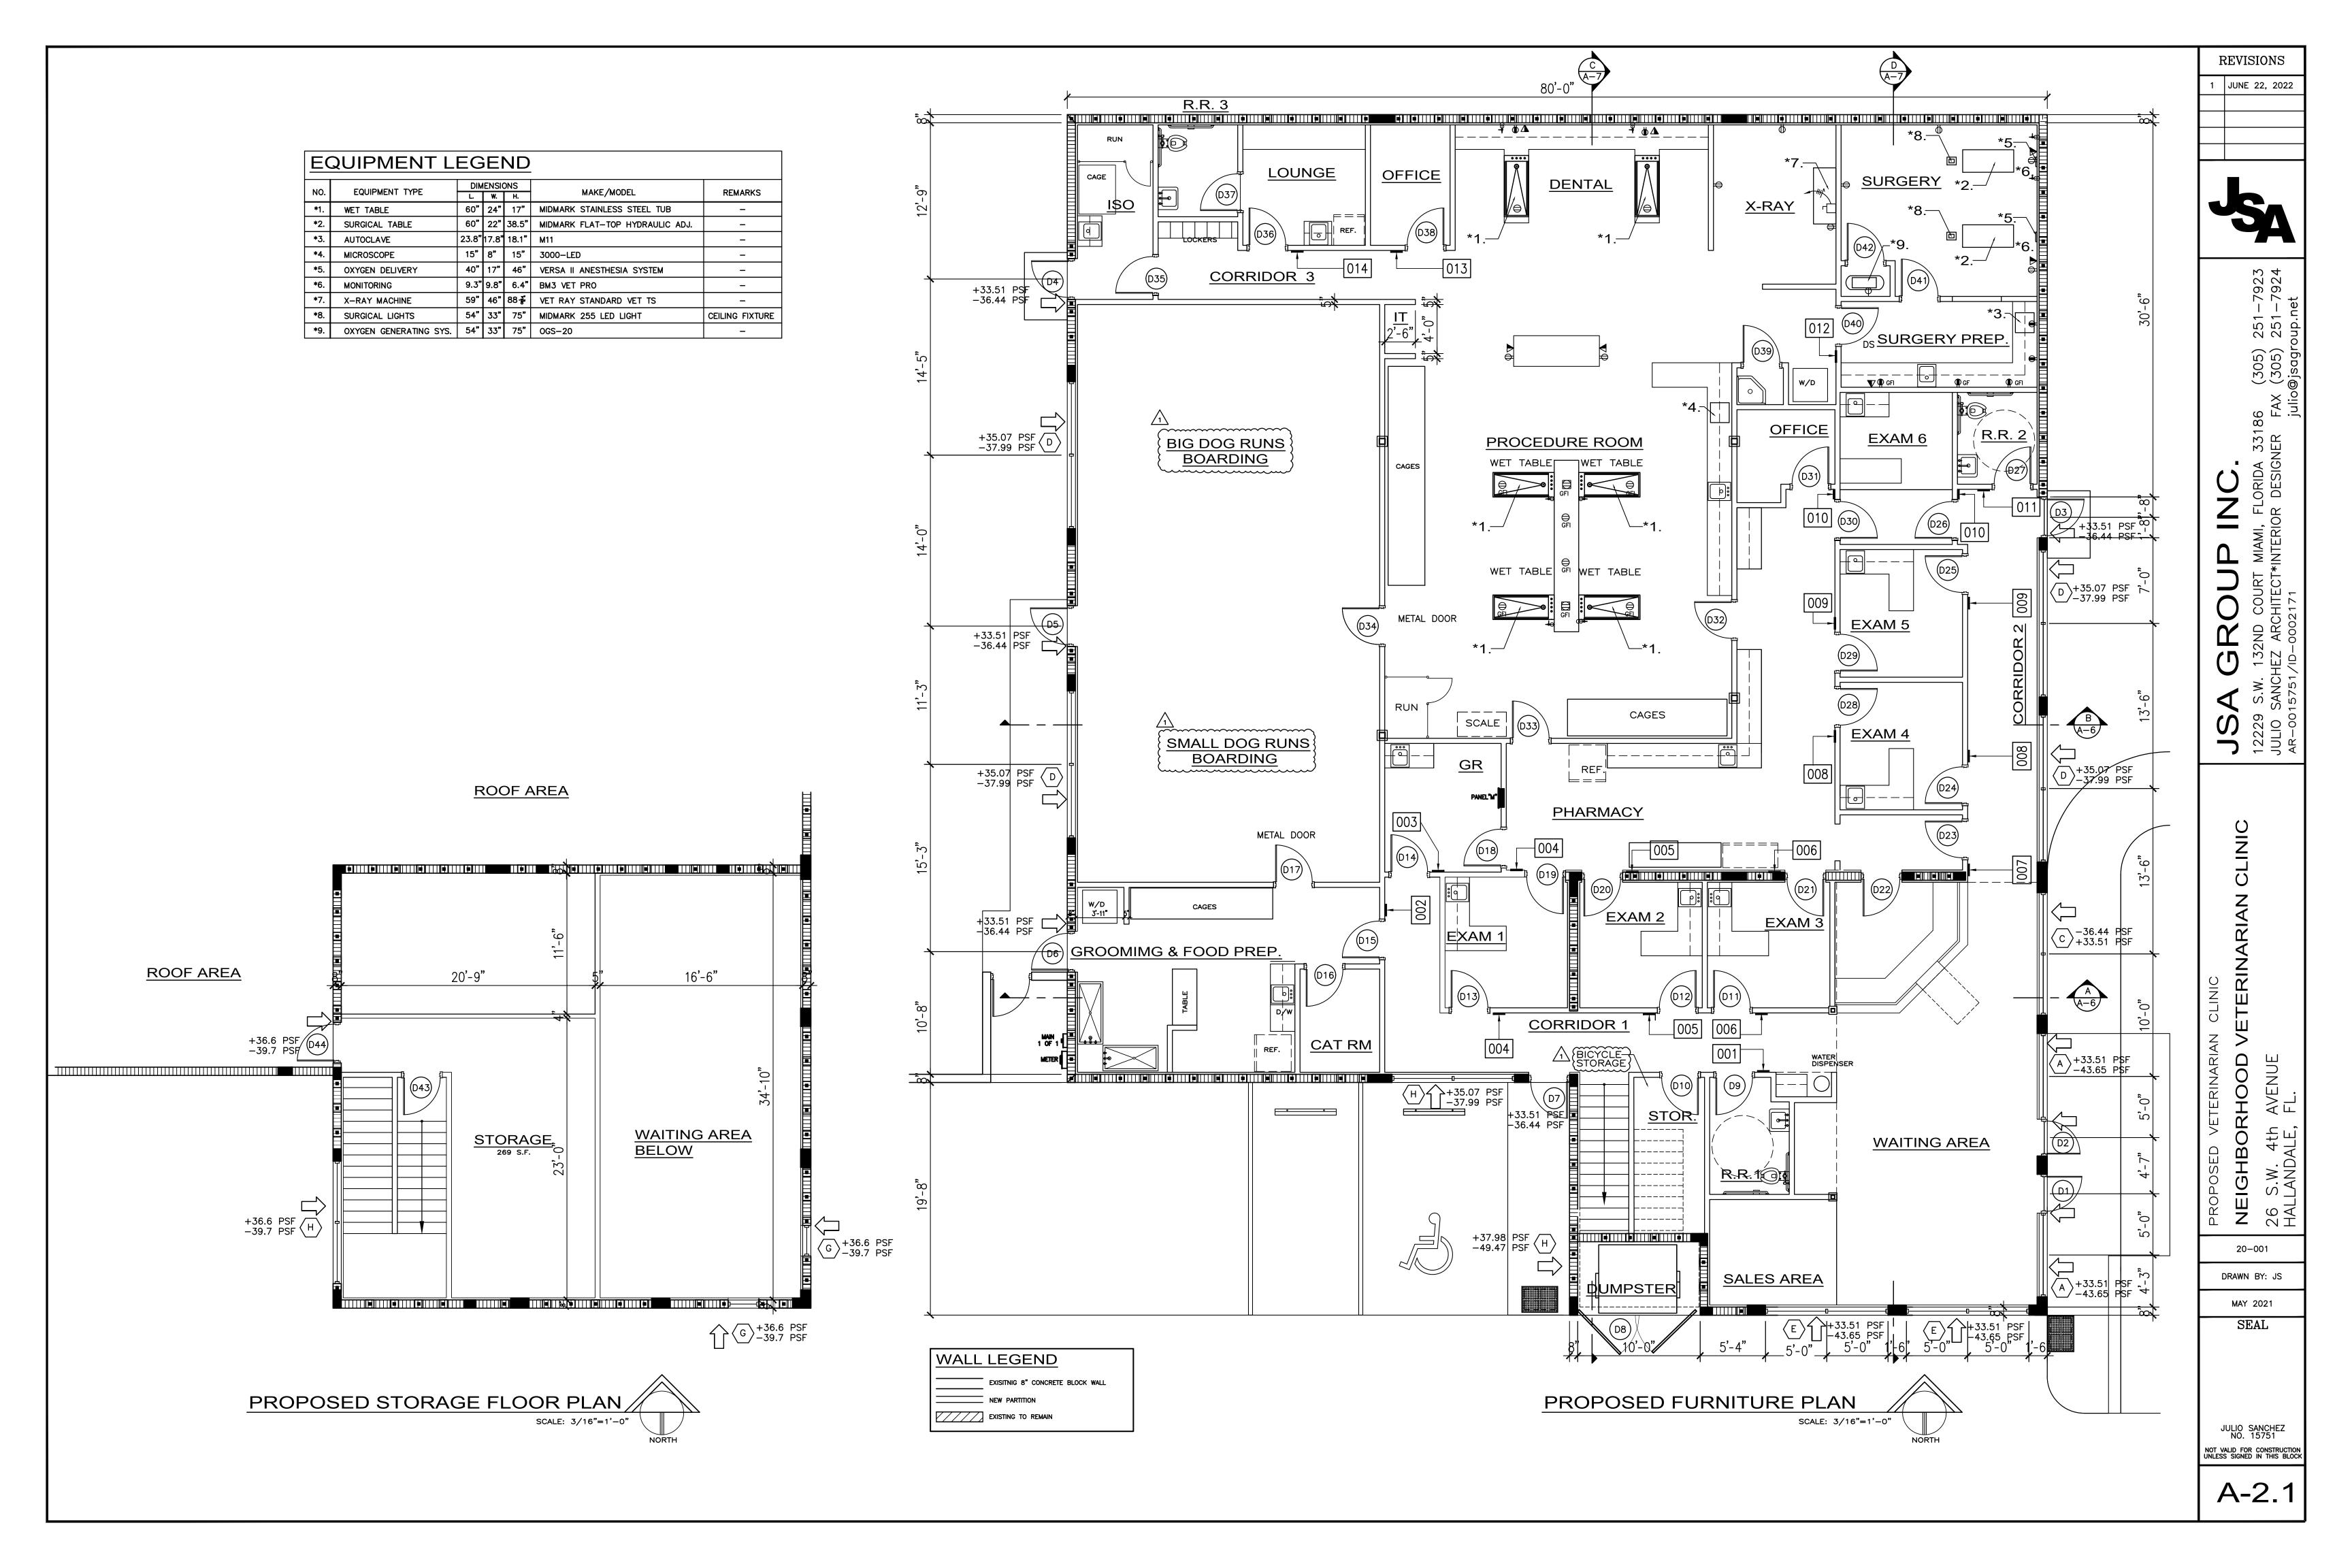



. REMOVE ALL CONDENSATE PIPES FOR NEW ROOF AND RE- CONNECT (TYPICAL)

2. ALL EXISTING PACKAGE UNITS SUPPORT HOT TAR TO BE REMOVED FROM PANS AND RE-SEALED WITH HOT TAR (TYPICAL)

3. ALL ROOF PENETRATIONS TO BE RESEALED, SEE DETAILS AND SPECIFICATIONS.

4. ALL INSULATION TO BE TAPERED TO CREATE A 4" ROOF SLOPE AS INDICATED ON PLANS.


5. PROVIDE THE REQUIRED ROOF INSULATION THICKNESS SO THAT THE TOTAL ROOF ASSEMBLY WILL ACHIEVE AN AVERAGE INSULATION VALUE OF R-20. THE CONTRACTOR SHALL PROVIDE, AT THE TIME OF SHOP DRAWING SUBMITTAL, A TOTAL ASSEMBLY CROSS SECTION SHOWING THE R-11 FOR EACH OF THE ROOF ELEMENTS AND THE TOTAL R-VALUE EXPECTED TO BE ACHIEVED UPON COMPLETION OR THE ROOFING SYSTEM.

6. THE ACTUAL SLOPE OF THE ROOF MUST BE 1/4" PER LINEAR FOOT (MINIMUM) AND THE CRICKETS MUST SLOPE AT 1/2" PER LINEAR FOOT (MINIMUM)

7. SOME ROOF AREAS MAY REQUIRE A COMBINATION OF ADDITIONAL TAPERED INSULATION & LIGHTWEIGHT CONCRETE IN ORDER TO MAINTAIN THE REQUIRED SLOPES AND HIGH AND LOW POINTS AS INDICATED IN THE DRAWINGS.


8. PROVIDE CRICKETS AT ALL EQUIPMENT CURBS, ROOF SCUTTLES & PRE-FABRICATED HEAT/SMOKE VENTS AT 1/2" PER LINEAR FOOT (MINIMUM) SO AS TO PREVENT WATER ACCUMULATION AT THE CURBS.


9. THE CONTARACTOR/ROOFING INSTALLER SHALL COORDINATE THE FINAL ROOF OPENING LOCATIONS WITH OTHER TRADES AND THE M.E.P. DRAWINGS SO THAT ALL PENETRATIONS WILL HAVE BEEN LOCATED AND COMPLETED PRIOR TO THE PLACEMENT OF THE LIGHTWEIGHT CONCRETE.

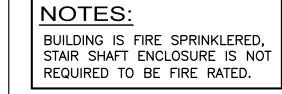

NOTES:

FOR ROOF WIND PRESSURES REFER TO STRUCTURAL PLANS DWG. SHEET S-2

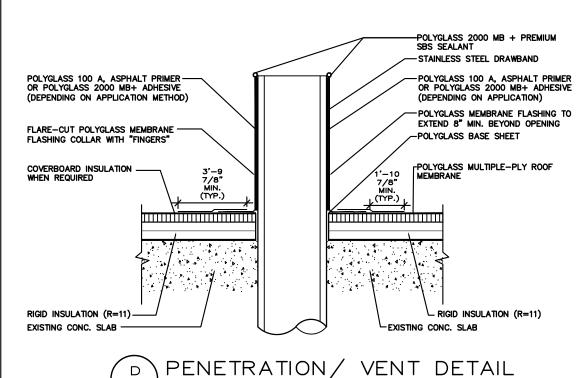

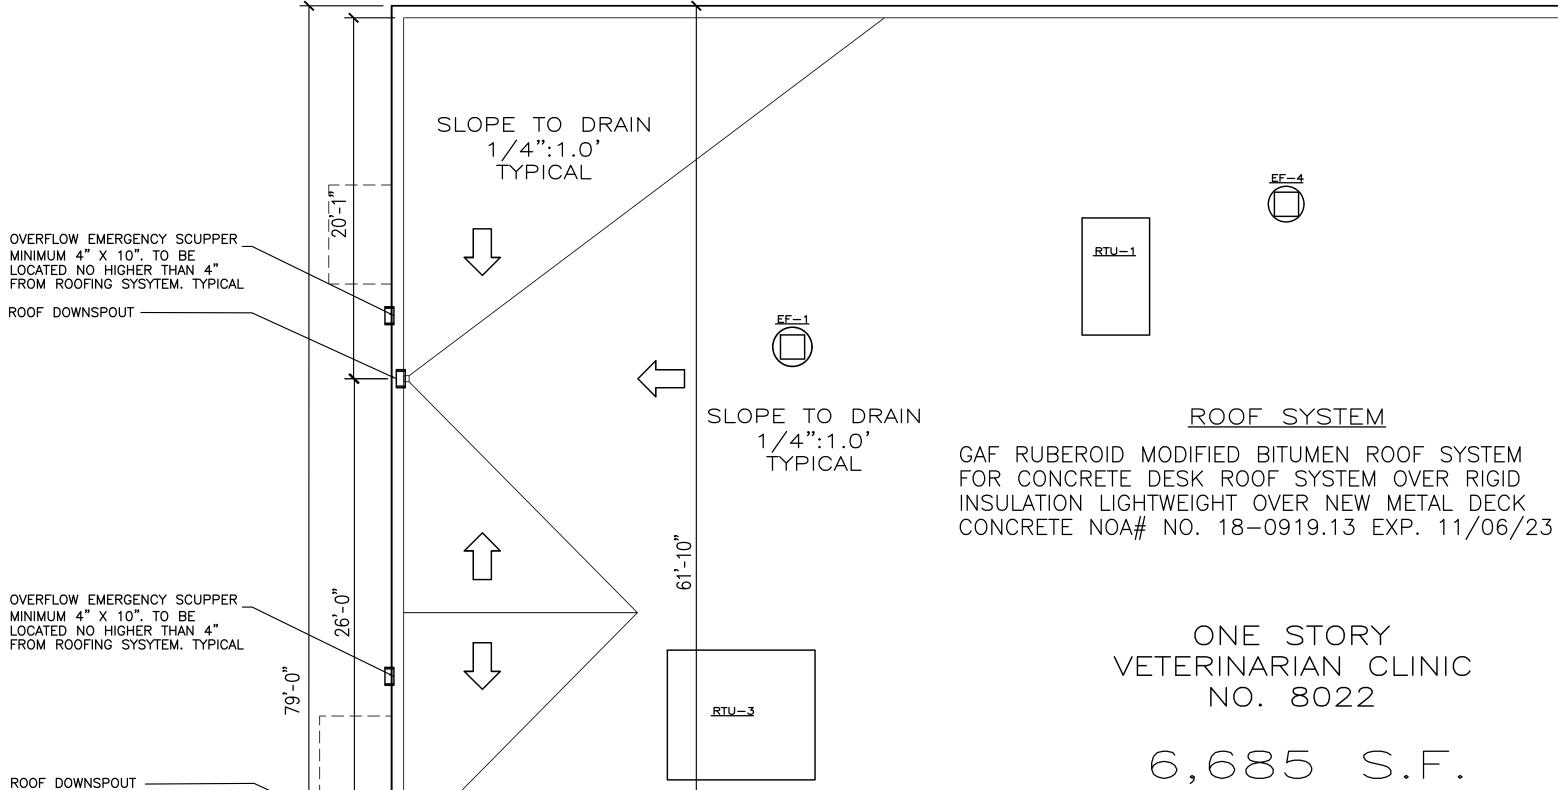

SLOPE TO DRAIN 1/4":1.0" TYPICAL

41'-0"


SLOPE TO DRAIN

1/4":1.0' TYPICAL

ELECTRICAL GENERATOR

REMOTE-MANUAL STOP STATION

80'-0"

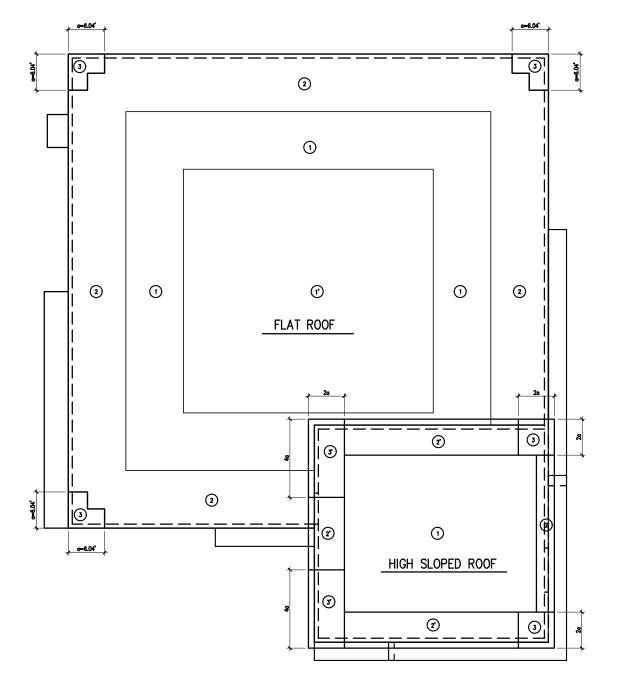



FLAT ROOF


GROSS ROOF UPLIFT VALUES (PSF.)

	AREA a=6.04'	ZONE (1)	ZONE (1')	ZONE 2	ZONE 3
	0 sqft ≤10 sqft	+15.58 -61.04	+15.58 -35.07	+35.07 -80.52	+35.07 -109.74
	10 sqft ≼ 🕰 20 sqft	+14.61 -57.02	+14.61 -35.07	+33.51 -75.35	+33.51 -99.40
	20 sqft ≤ A≤ 50 sqft	+13.32 -51.69	+13.32 -35.07	+31.46 -68.50	+31.46 -85.70
	50 sqft ≼ A≤ 100 sqf	+12.34 -47.66	+12.34 -35.07	+29.91 -63.32	+29.91 -75.34
Ľ					

SLOPED ROOF

GROSS ROOF UPLIFT VALUES (PSF.)

AREA a=3.9'	ZONE 1	ZONE (2)	ZONE (2')	ZONE 3	ZONE 3')
0 sqft ≤10 sqft	+17.66	+17.66	+17.66	+17.66	+17.66
	-47.10	-54.46	-65.50	-72.86	-102.30
10 sqft ≤ A≤ 20 sqft	+16.56	+16.56	+16.56	+16.56	+16.56
	-47.10	-53.36	-64.40	-66.22	-91.24
20 sqft ≤ A≤ 50 sqft	+15.09	+15.09	+15.09	+15.09	+15.09
	-47.10	-51.89	-62.93	-57.43	-76.58
50 sqft ≼ A≼ 100 sqf	+13.98	+13.98	+13.98	+13.98	+13.98
	-47.10	-50.78	-61.82	-50.78	-65.50

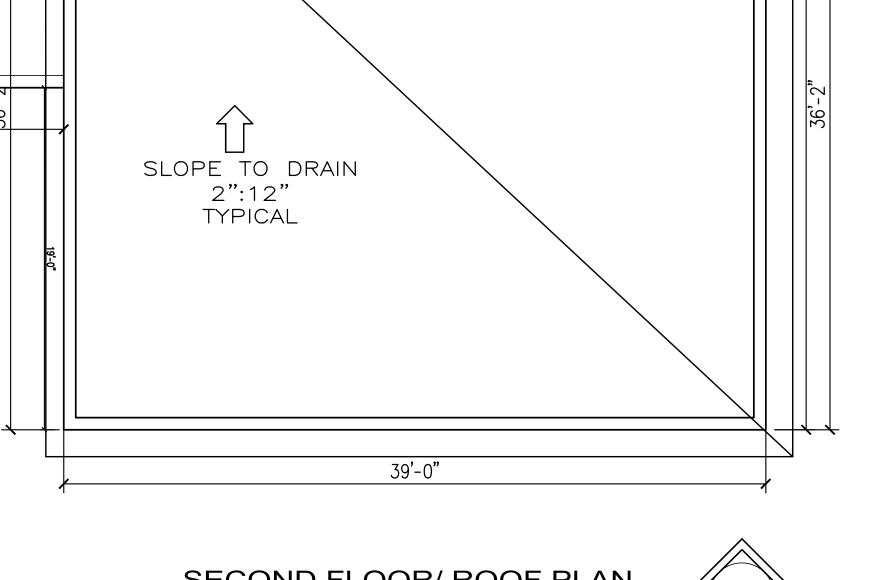


<u>RTU-2</u>

SLOPE TO DRAIN

2":12"
TYPICAL

SECOND FLOOR/ ROOF PLAN SCALE: 3/16"=1'-0"

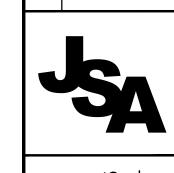

REVISIONS


7923 7924 251— 251—


2020-001 DRAWN BY: JS


MAY 2021 SEAL


JULIO SANCHEZ NO. 15751


A-3.1

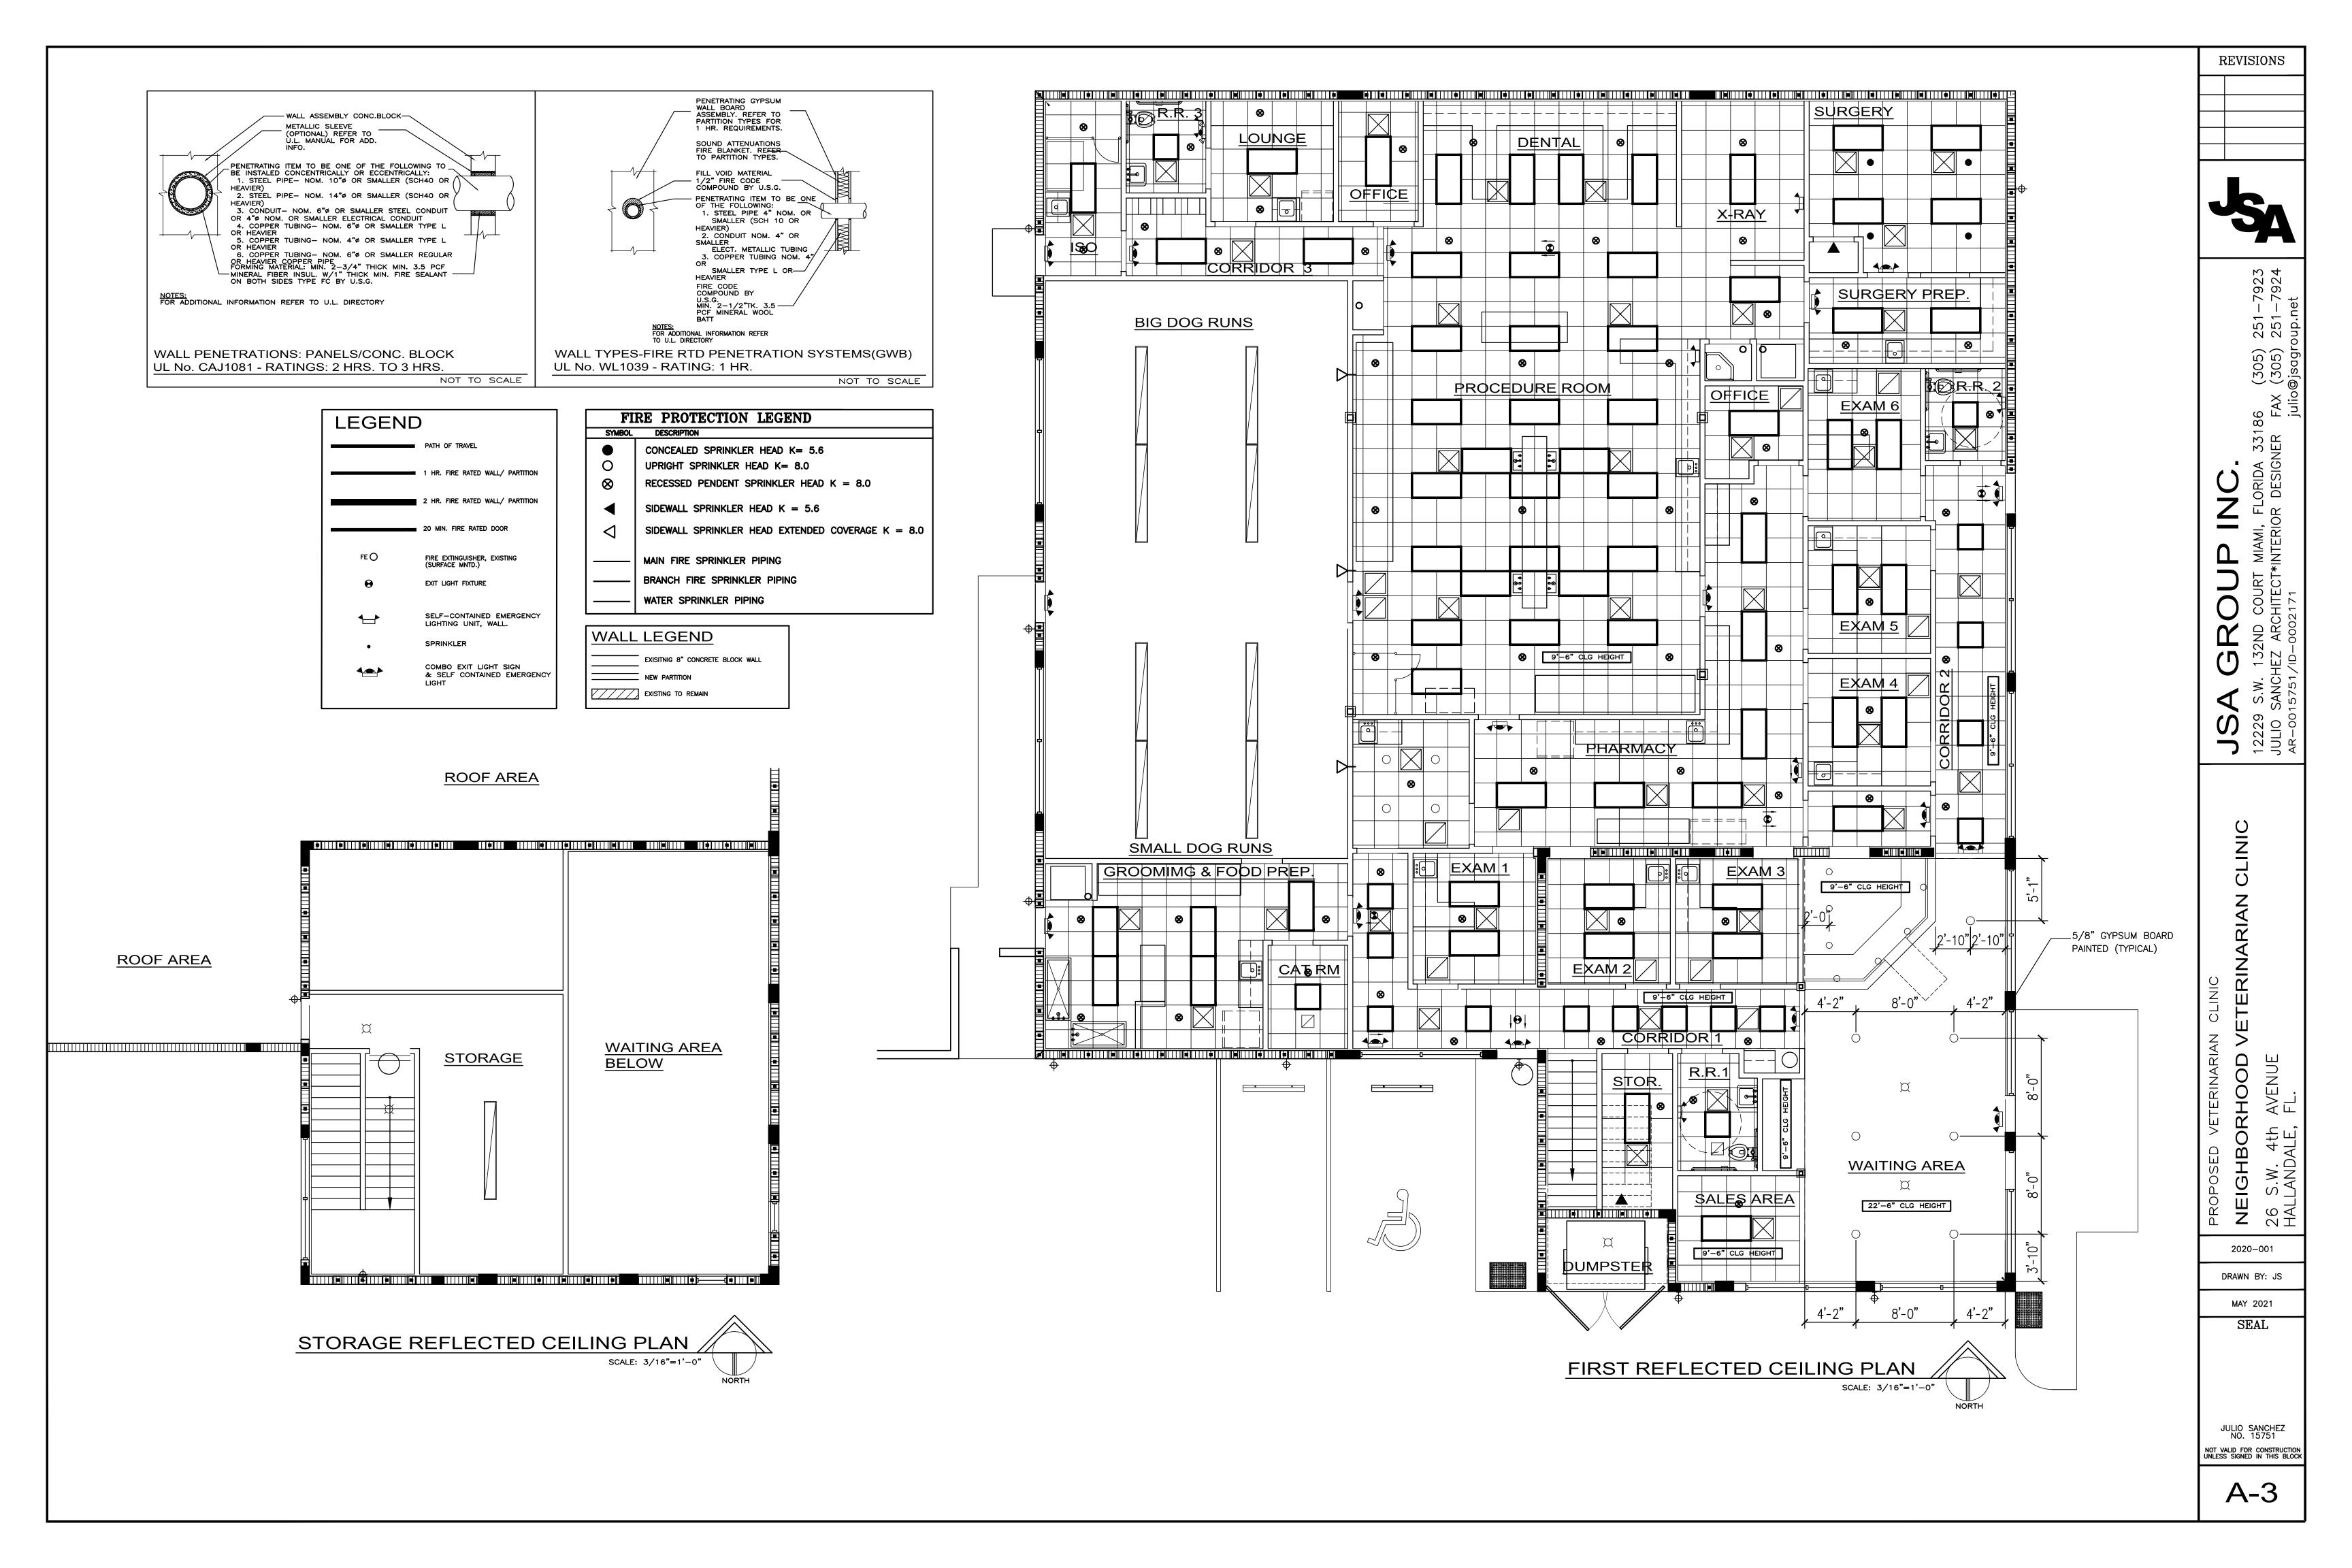

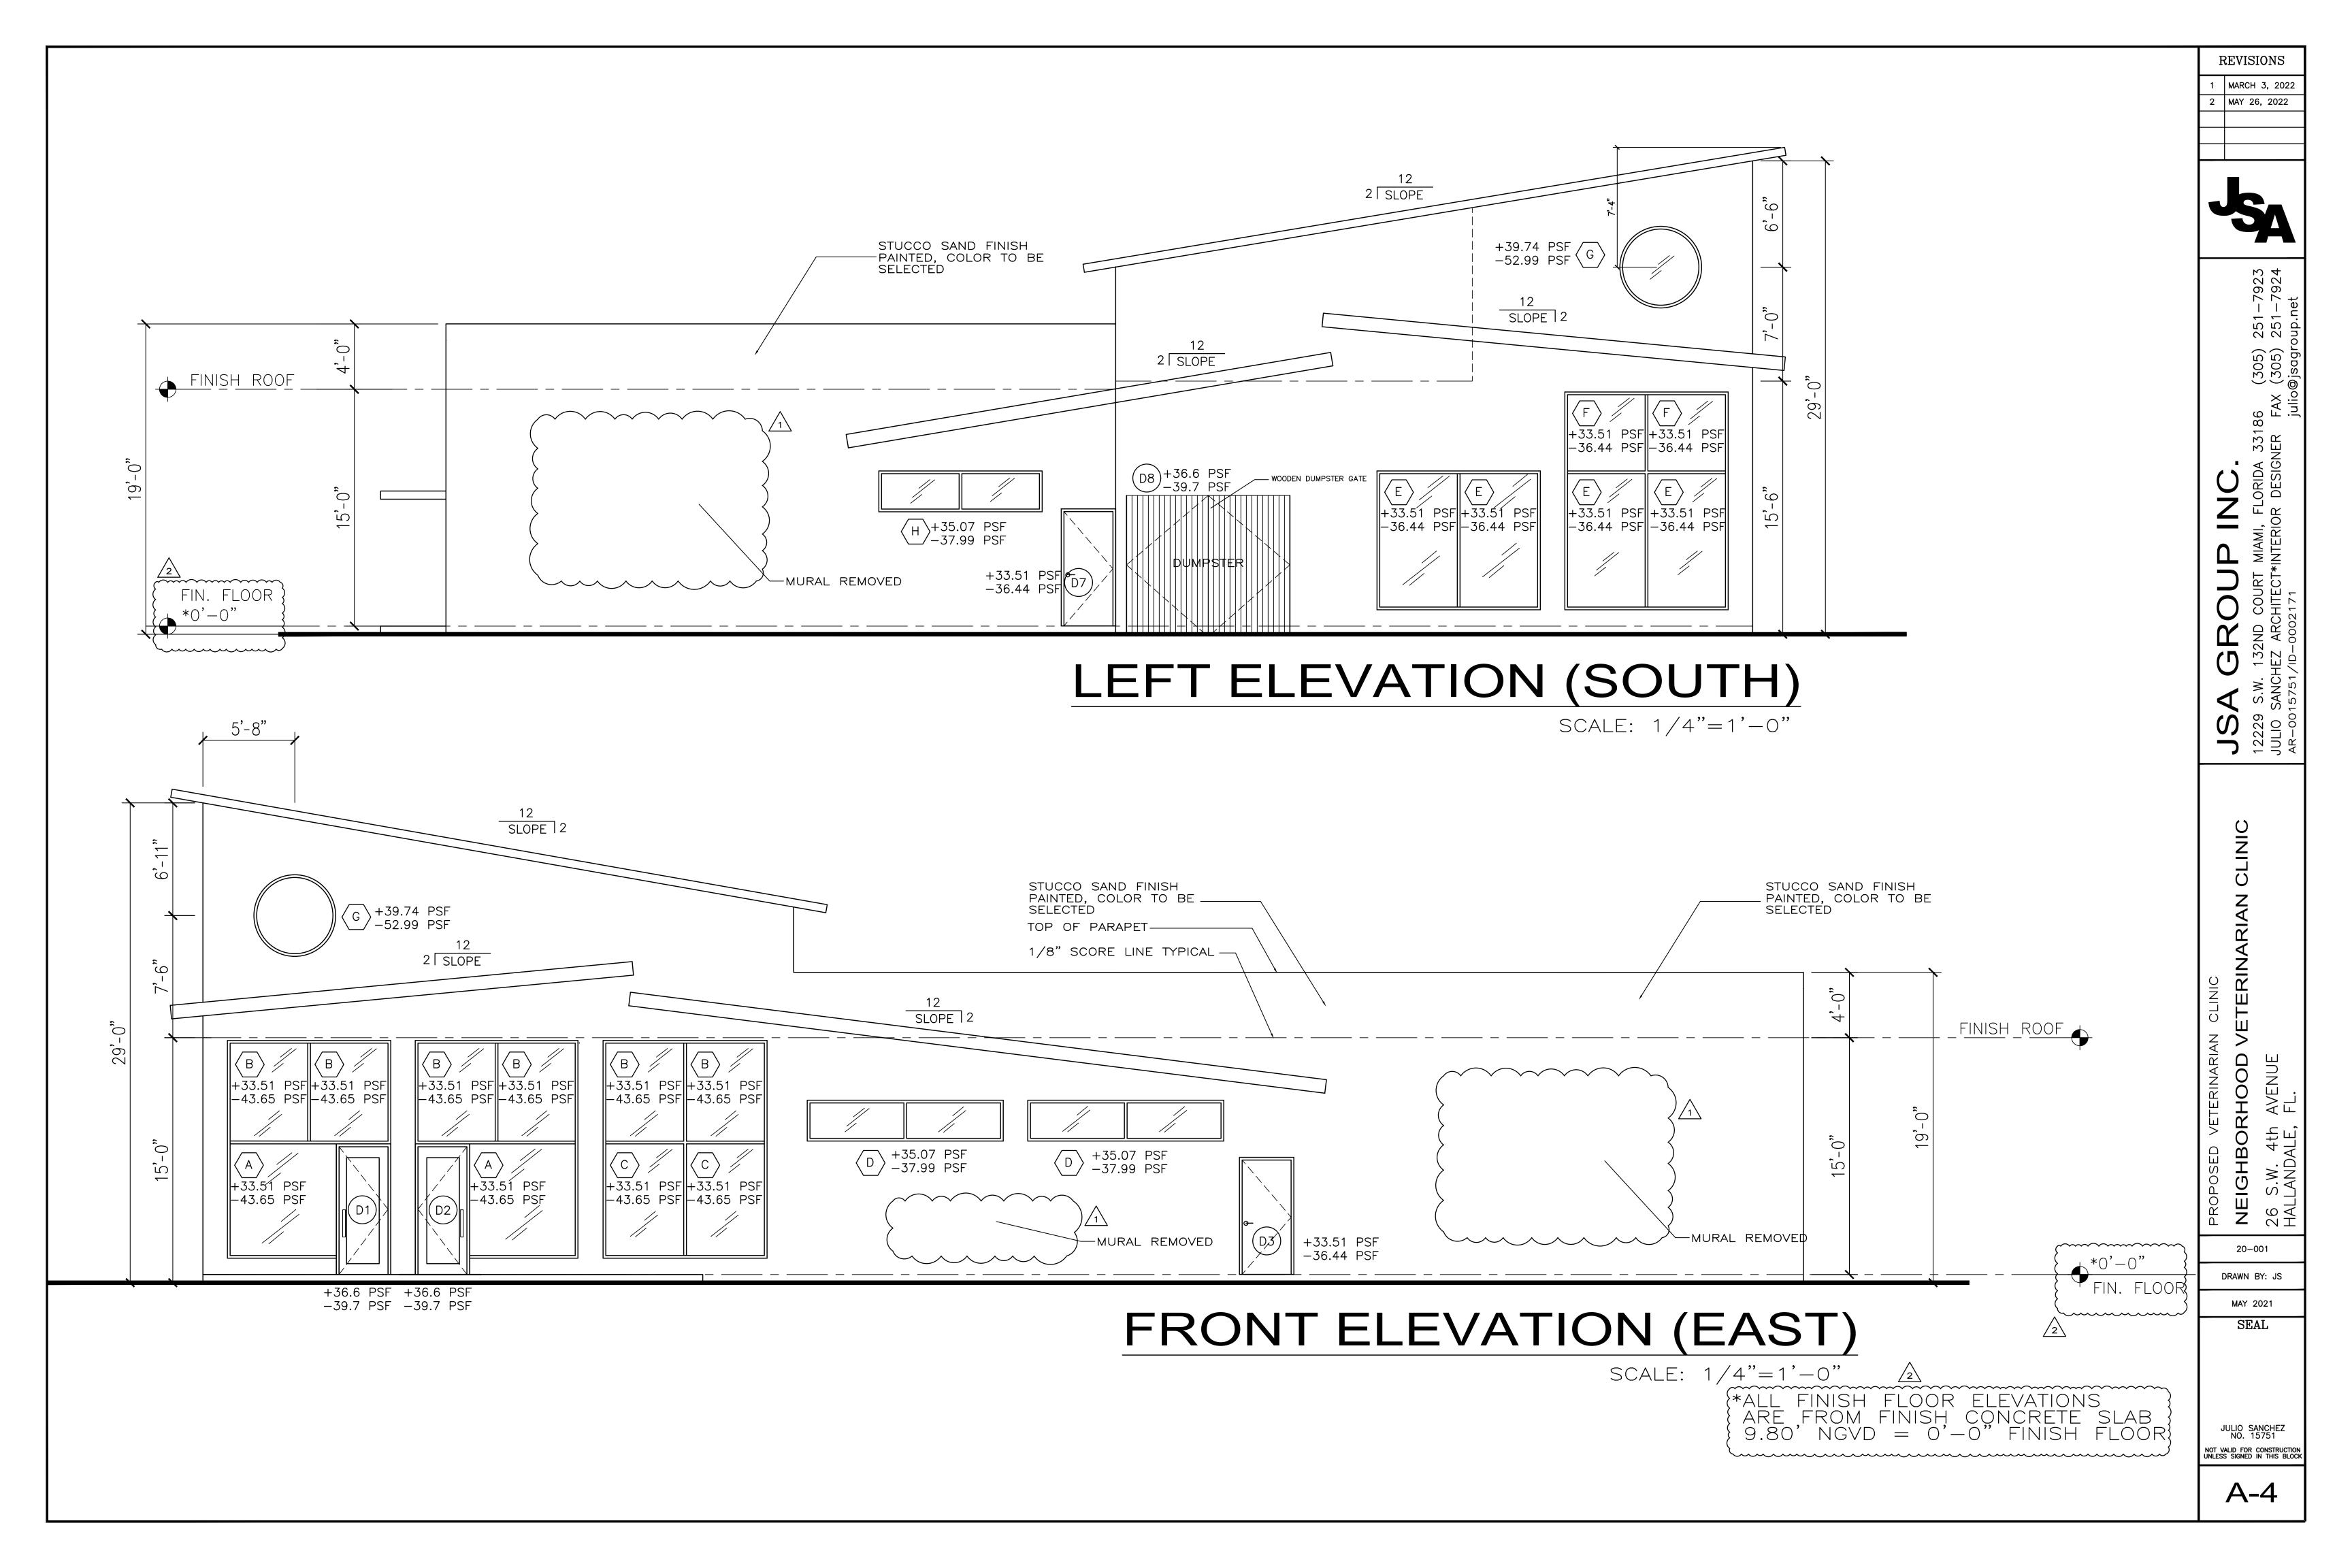

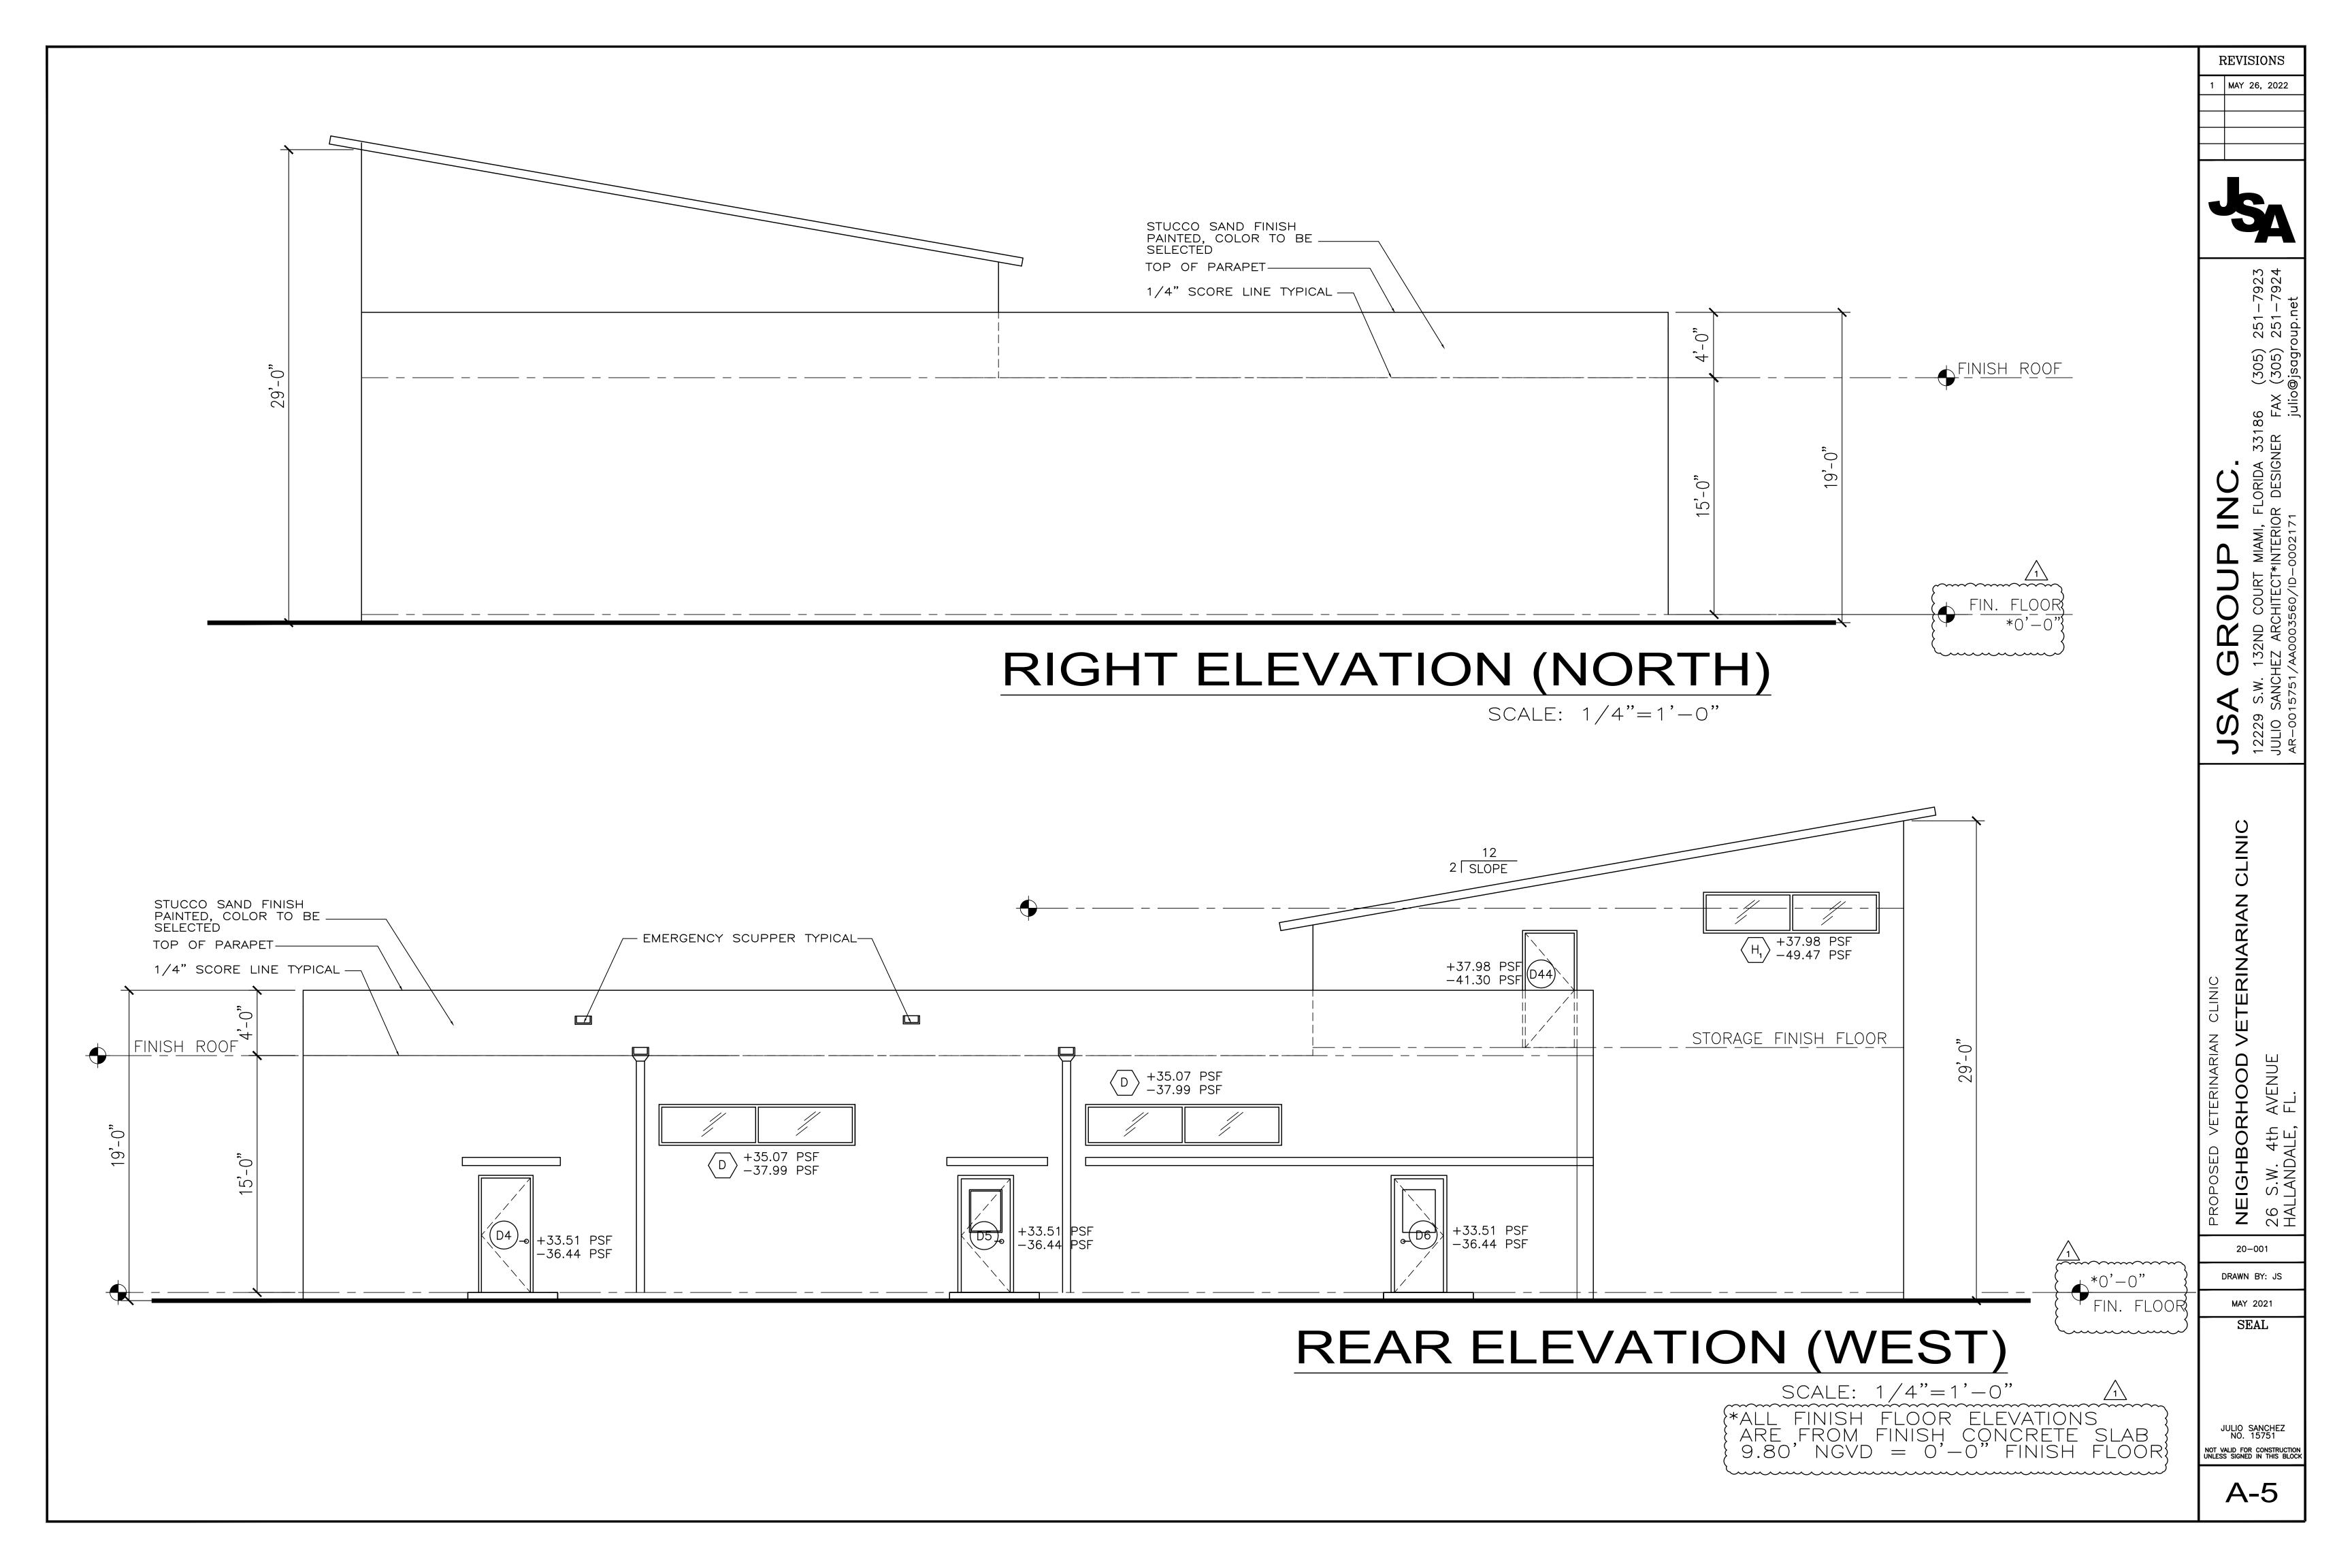

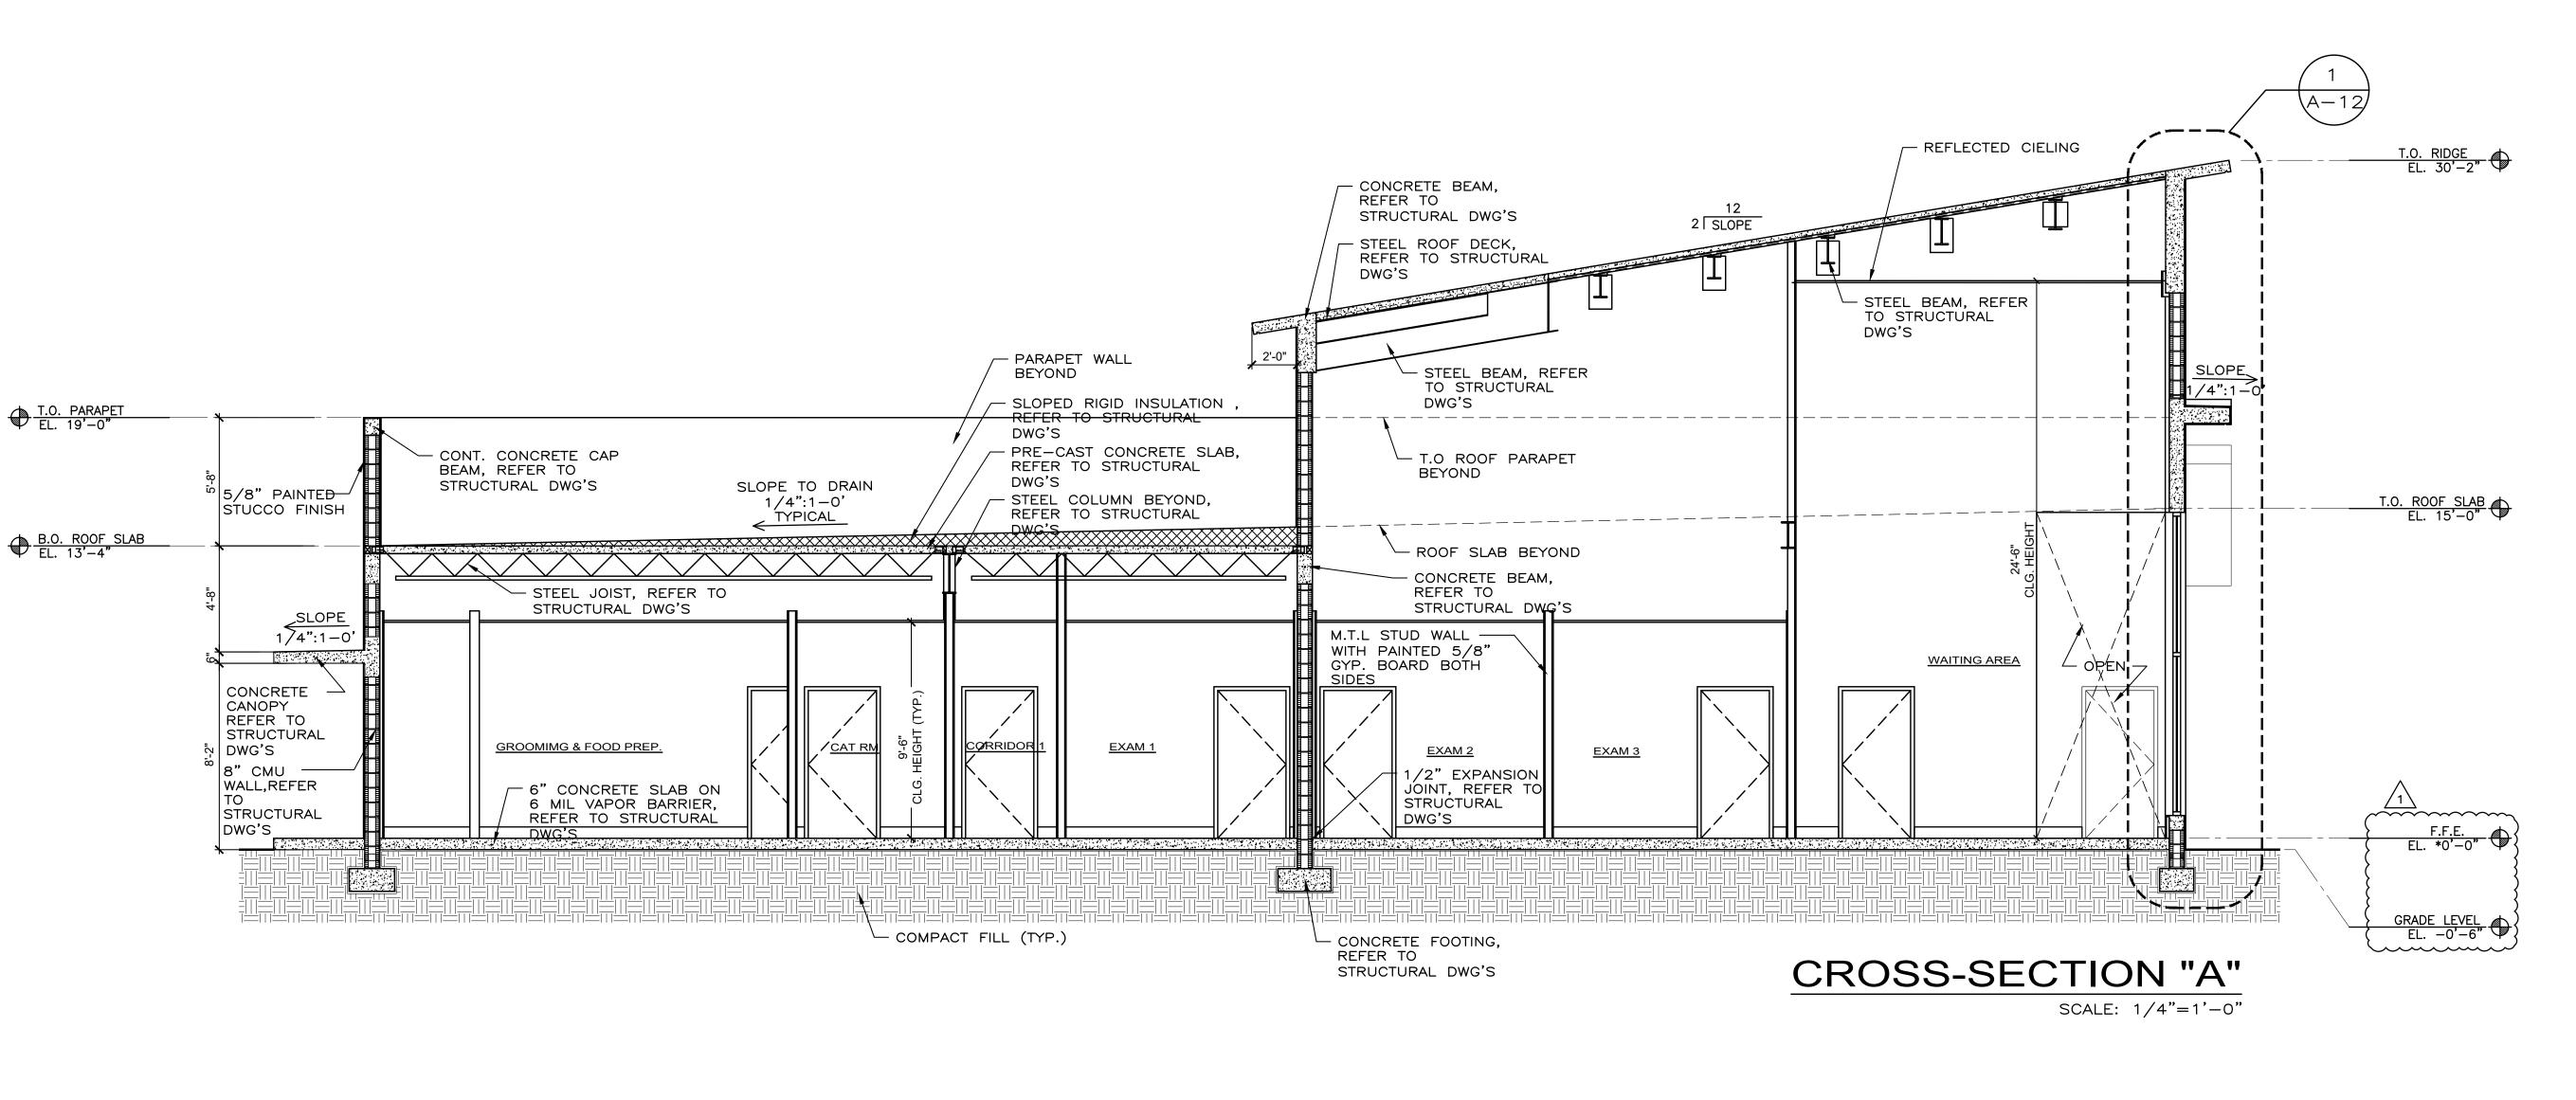

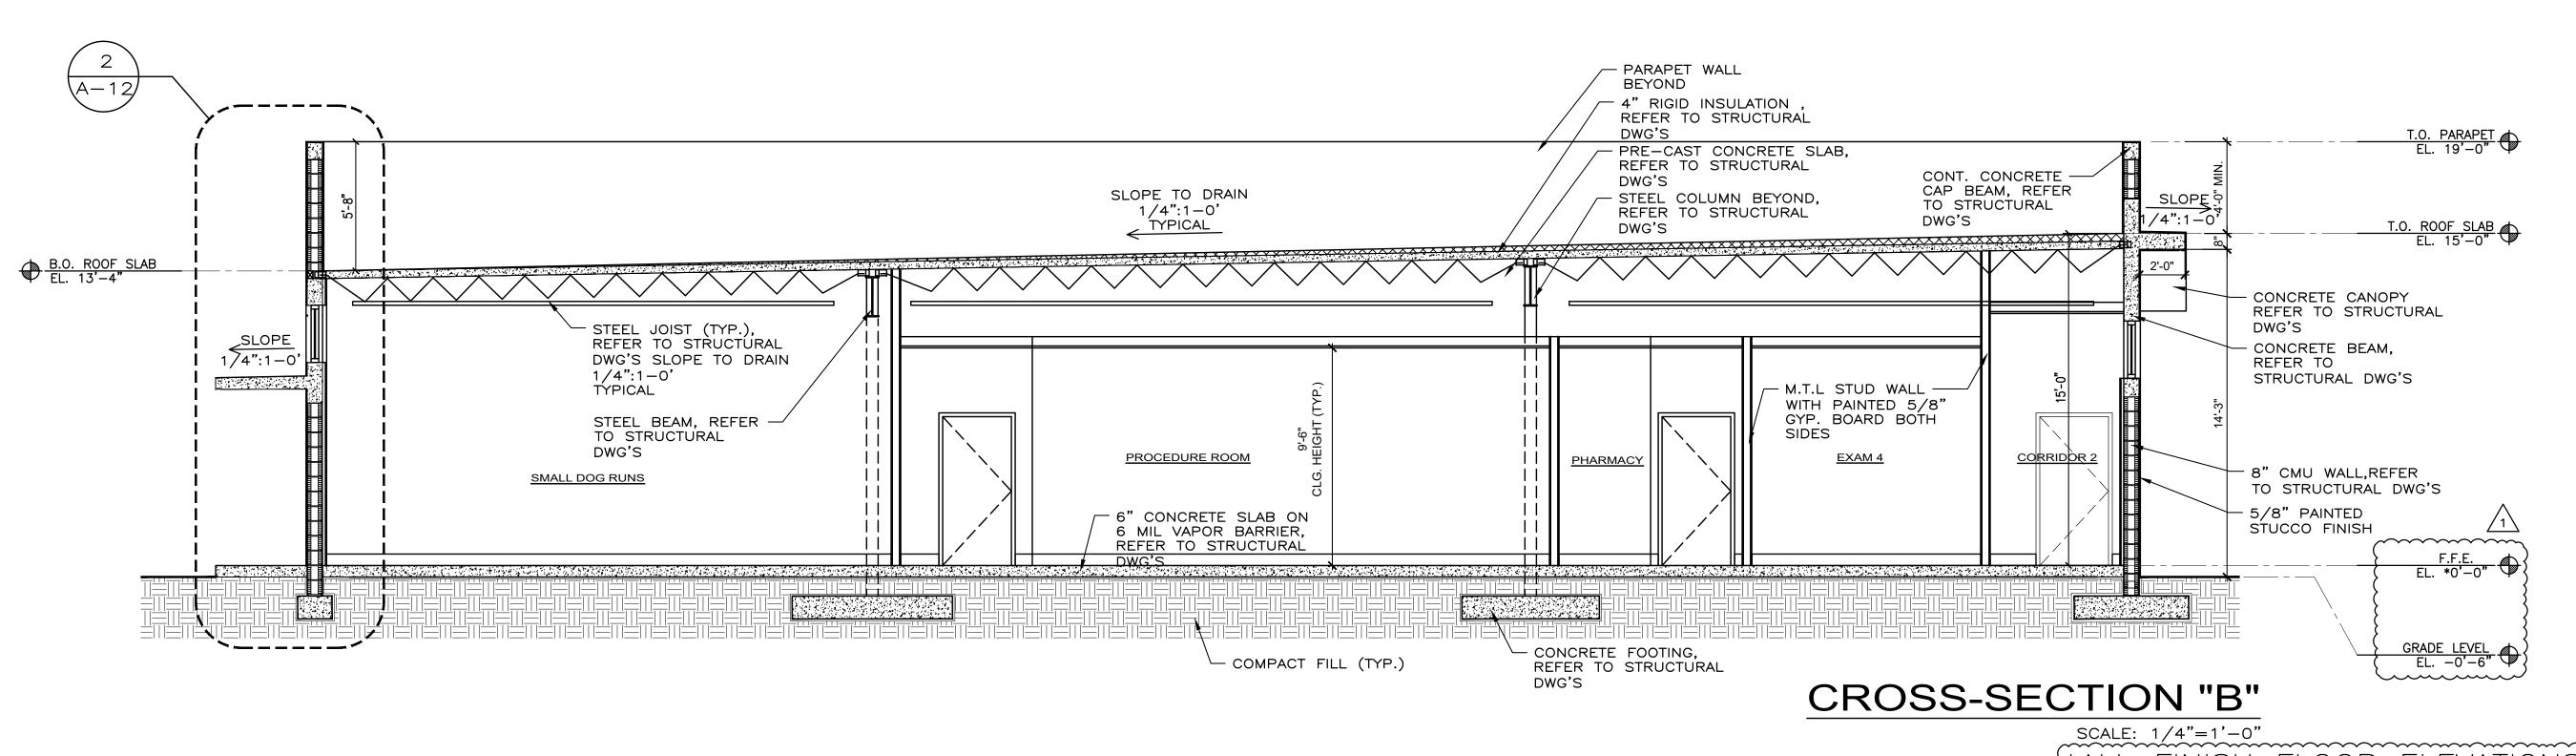

REVISIONS MAY 26, 2022

.7923 .7924

251— 251—

(305) (305) @jsagra

NOT VALID FOR CONSTRUCTION UNLESS SIGNED IN THIS BLOCK A-6

NGVD = O'-O''

JULIO SANCHEZ NO. 15751


KHOOD AVENUE FL


20-001

DRAWN BY: JS

MAY 2021

SEAL

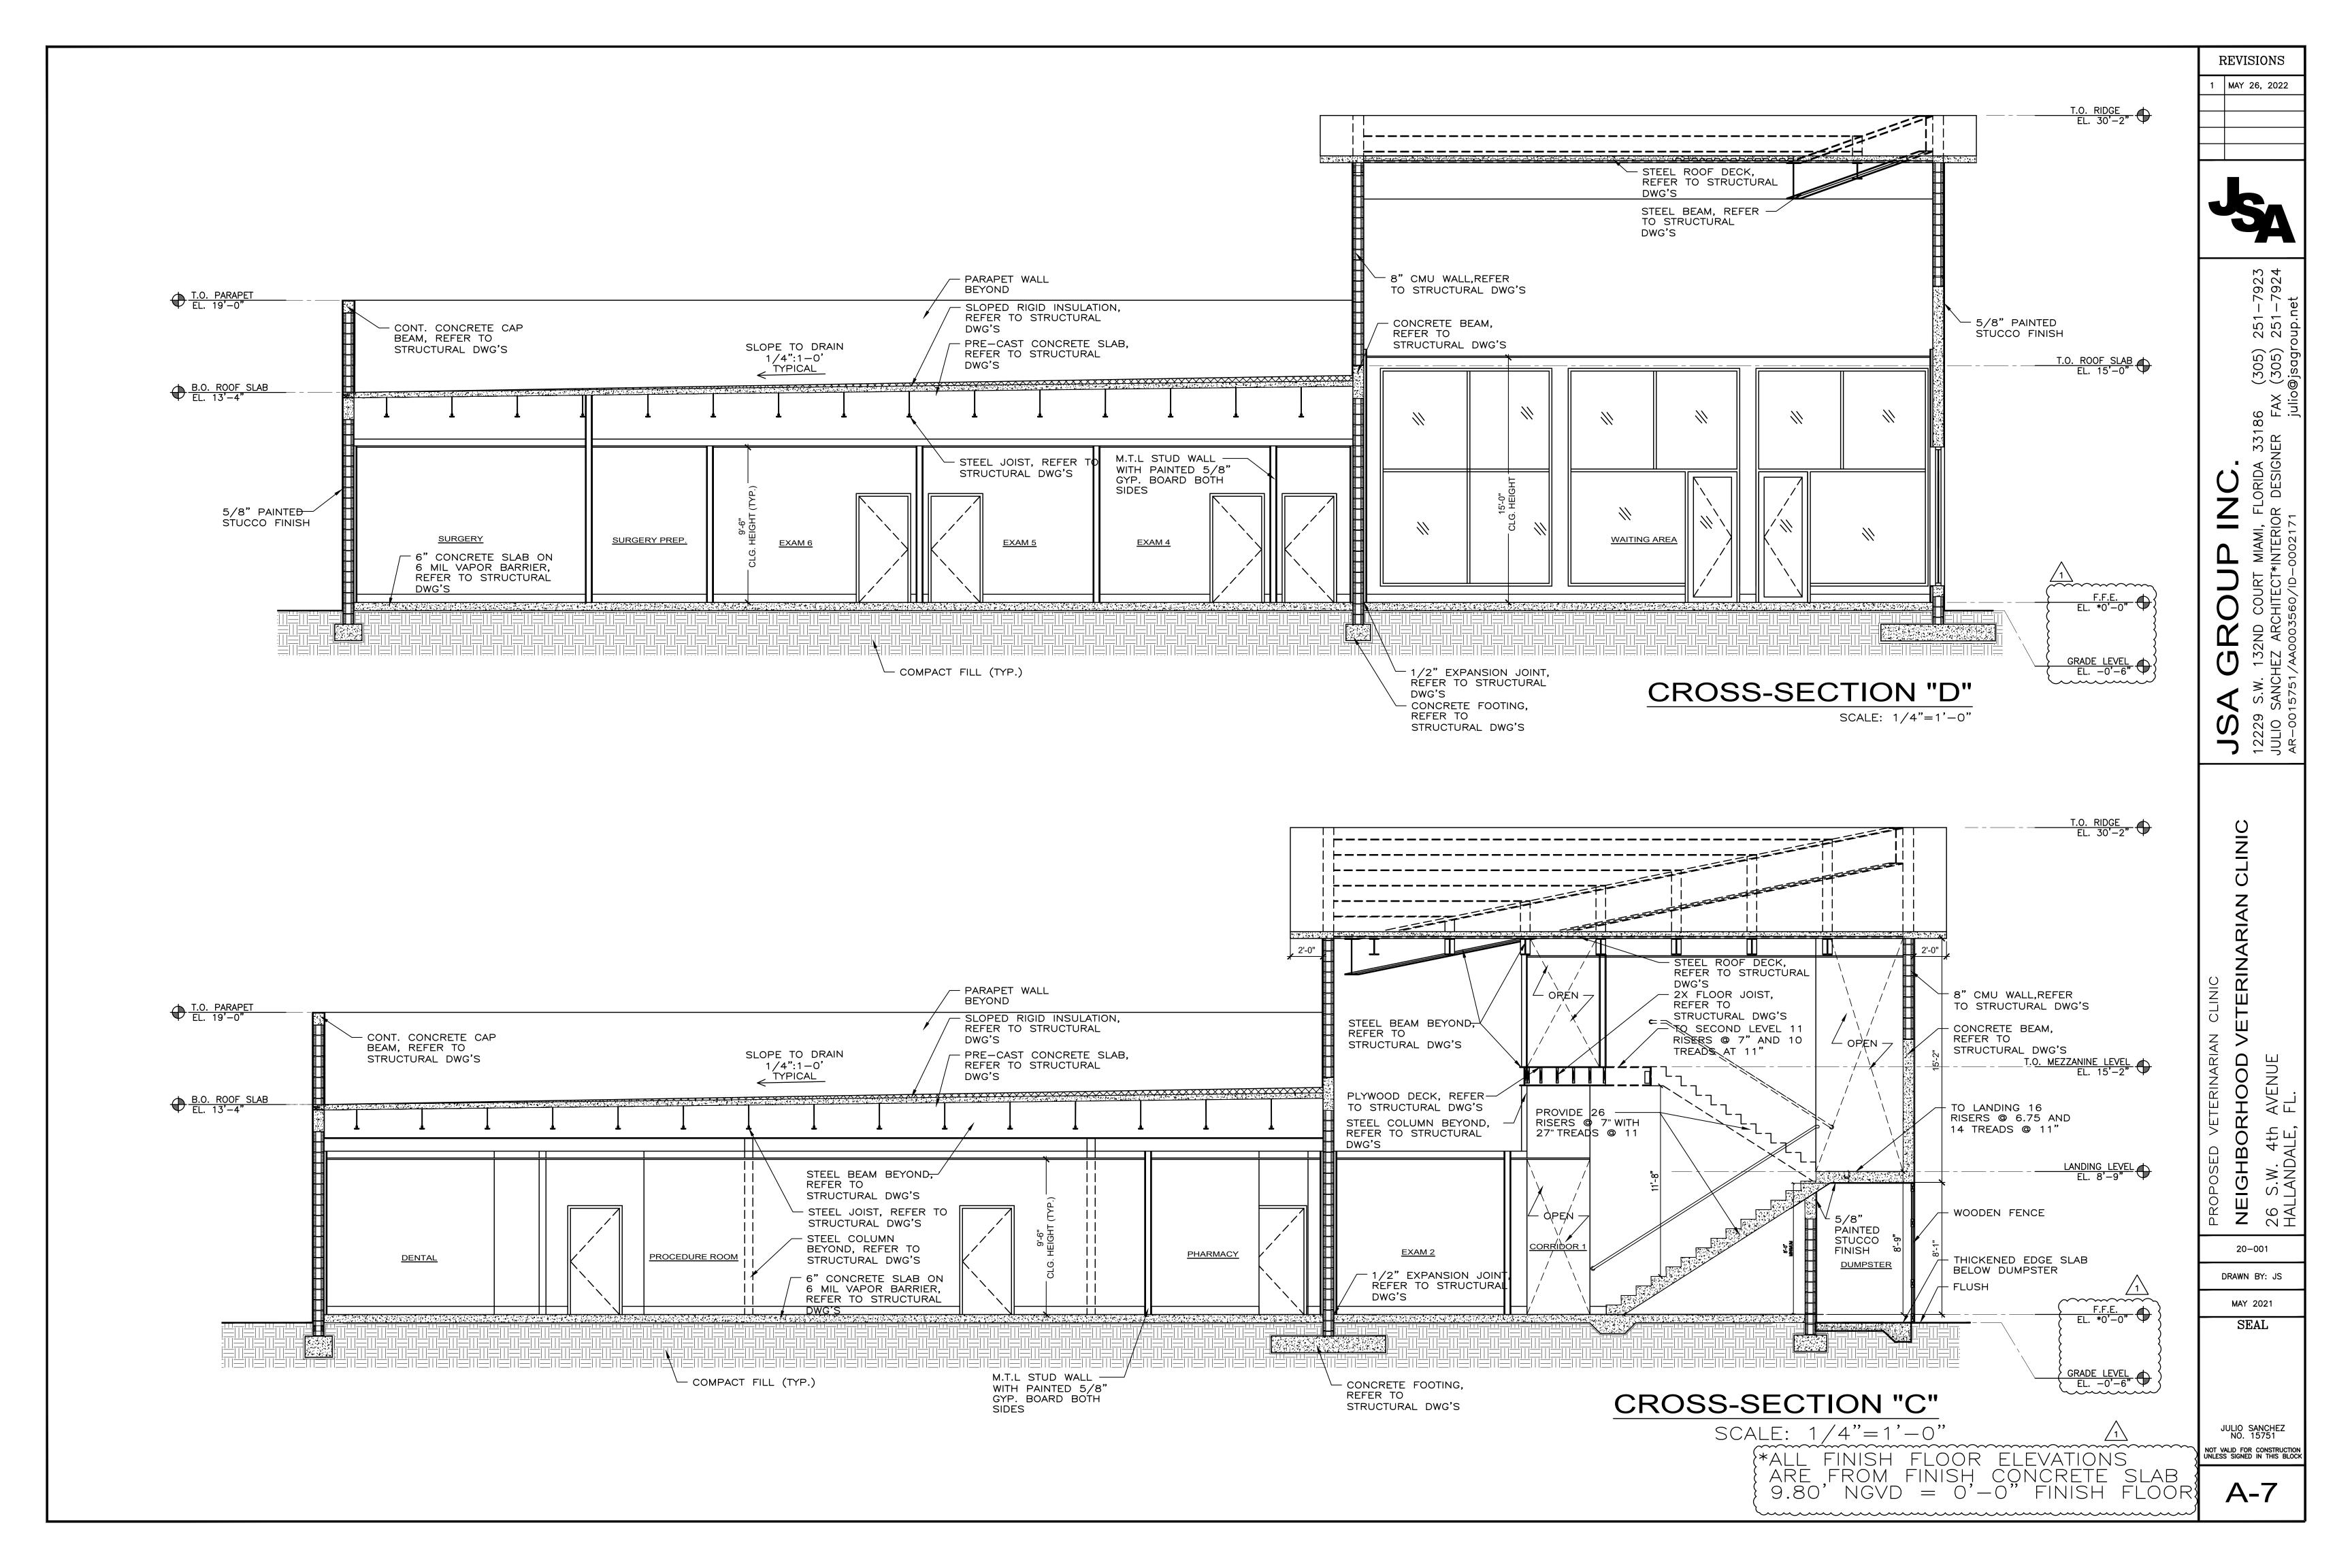

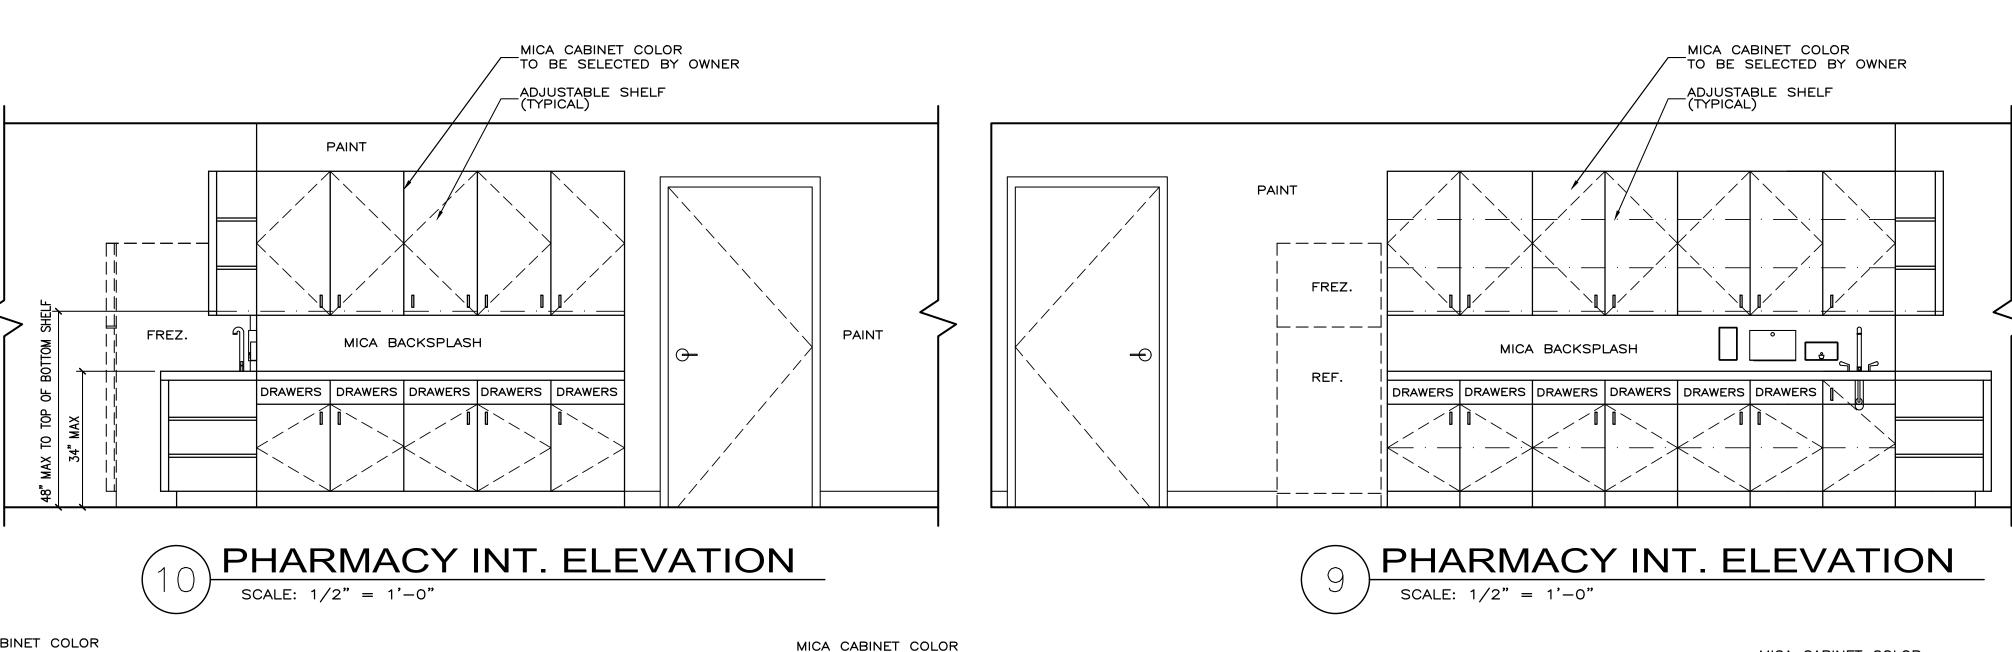




- SOAP DISPENSER MODEL U124, A&J WASHROOM ACCESSORIES TOILET PAPER DISPENSER MODEL B69997, BOBRICK WASHROOM ACCESSORIES 36" GRAB BAR
- D 42" GRAB BAR
- RECESSED COMBINATION TOWEL / WASTE UNIT MIRRORS MODEL U701S, A&J WASHROOM ACCESSORIES
- G UNDER SINK PROTECTIVE PIPE INSULATION

ELEVATIONS ARE ONLY REFERENCE TO PROPER HEIGHTS OF ACCESSORIES & FIXTURES

ALL ACCESSORIES TO BE STAINLESS STEEL ALL ACCESSORIES AND FIXTURES SHALL BE ADA COMPLIANT PRODUCTS AS PER


2017 FBC - ACCESSIBILITY, SIXTH EDITION


SEE SHEET A-6 FOR ADA COMPLIANT REACH DETAILS.

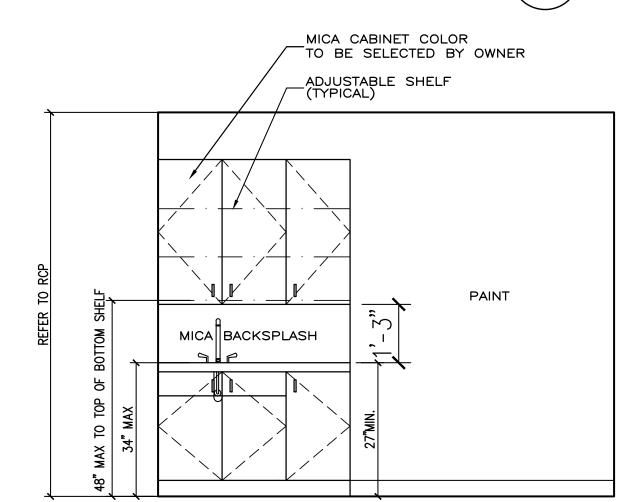

GR INT. ELEVATION


SCALE: 1/2" = 1'-0"

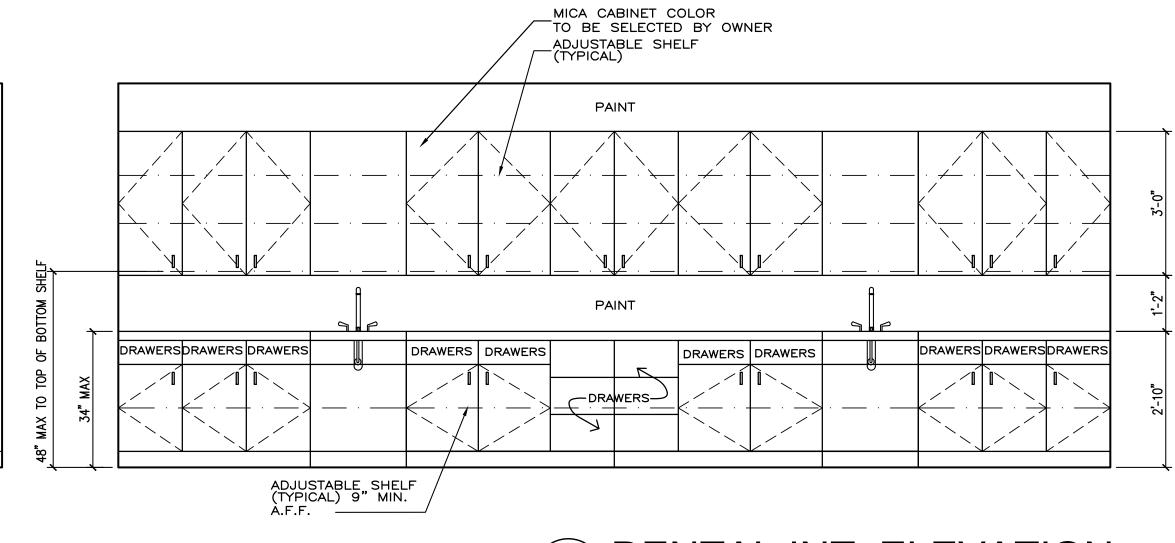

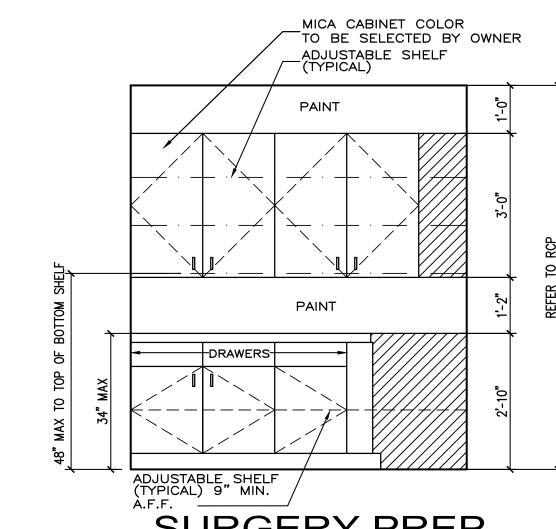



DENTAL INT. ELEVATION SCALE: 1/2" = 1'-0"




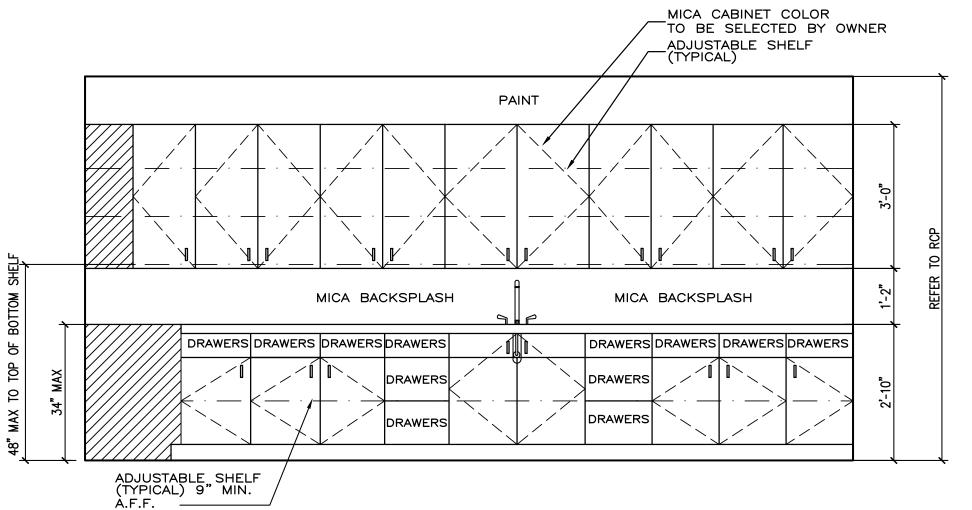


SURGERY PREP. INT. ELEVATION

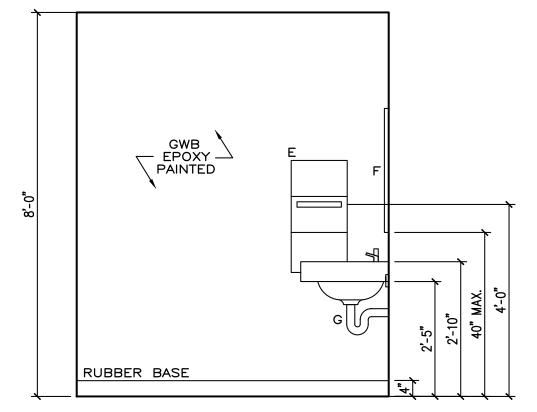

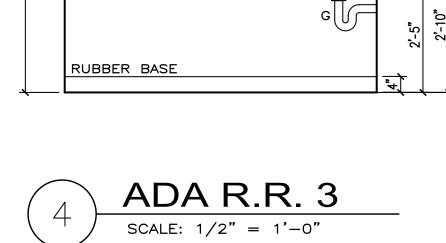


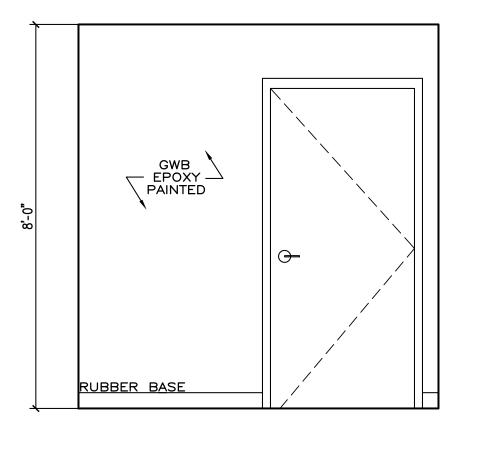



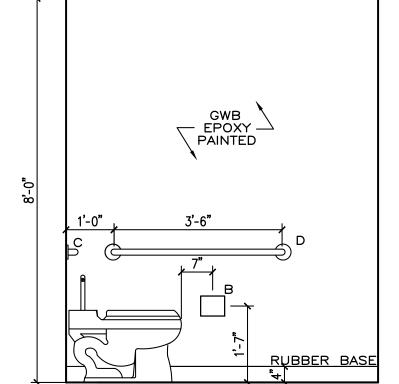



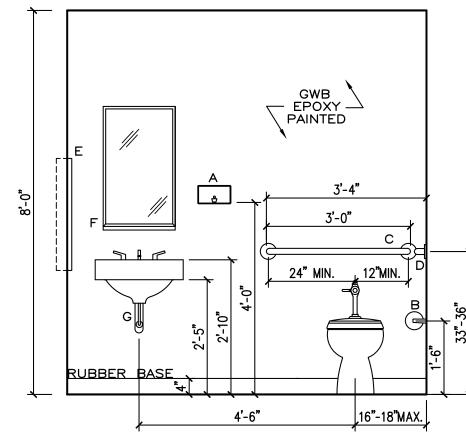

ADA R.R. 3

SCALE: 1/2" = 1'-0"

JULIO SANCHEZ NO. 15751 NOT VALID FOR CONSTRUCTION UNLESS SIGNED IN THIS BLOCK

20-001

DRAWN BY: JS

MAY 2021

SEAL

REVISIONS

.7923 .7924

251-

(305) (305) @jsagra

33186 VER F/



251-7923 251-7924 oup.net

20-001


DRAWN BY: JS


JANUARY 2021


SEAL


JULIO SANCHEZ NO. 15751 NOT VALID FOR CONSTRUCTION UNLESS SIGNED IN THIS BLOCK

A-9

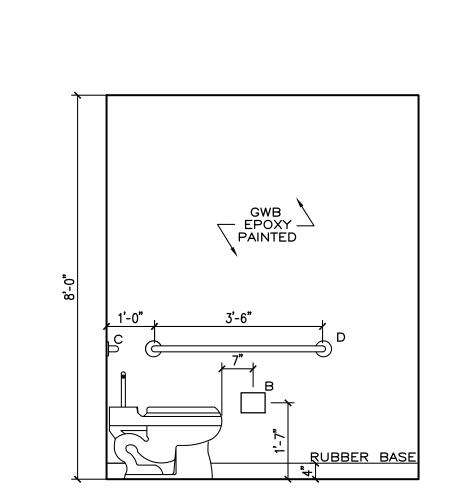

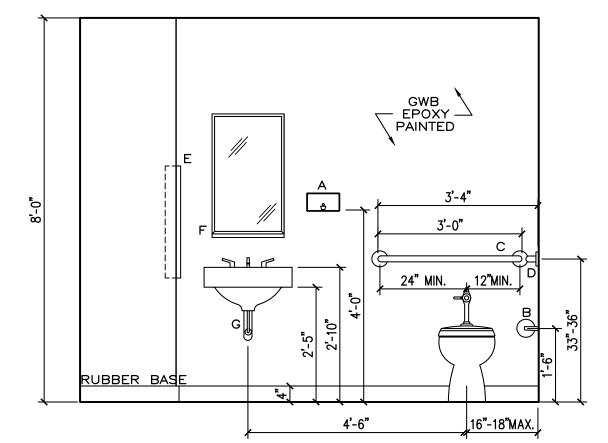

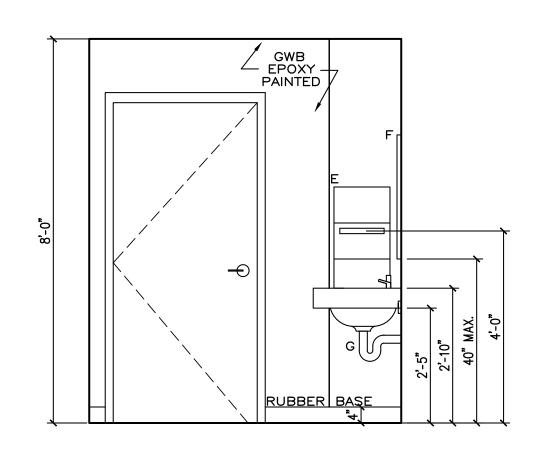

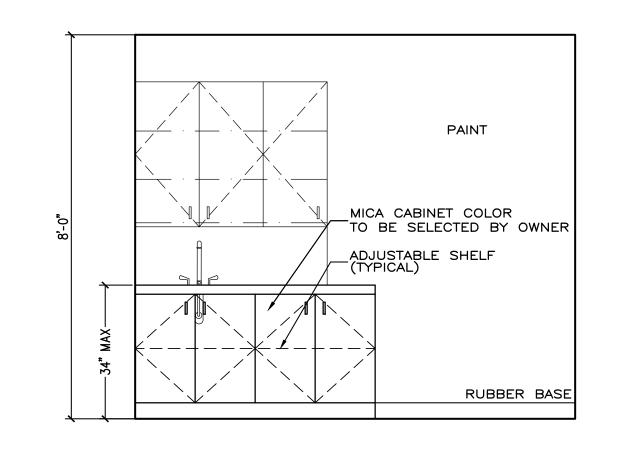

EXAM 6 INT. ELEVATION


RR 1 INT. ELEVATION SCALE: 1/2" = 1'-0"


GWB PAINTED


RR 1 INT. ELEVATION SCALE: 1/2" = 1'-0"


RR 1 INT. ELEVATION SCALE: 1/2" = 1'-0"

RR 1 INT. ELEVATION SCALE: 1/2" = 1'-0"

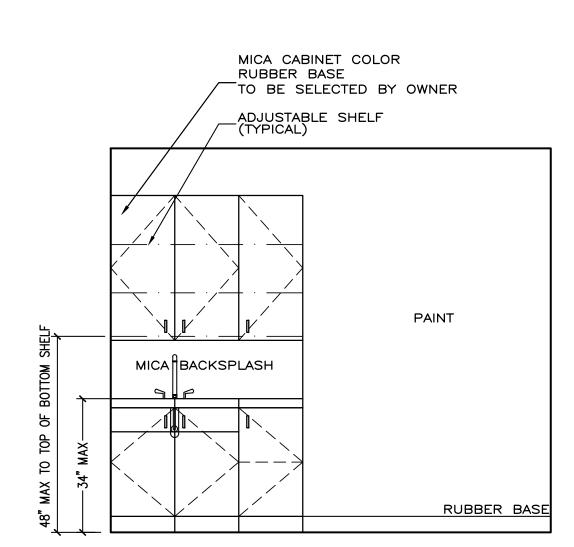

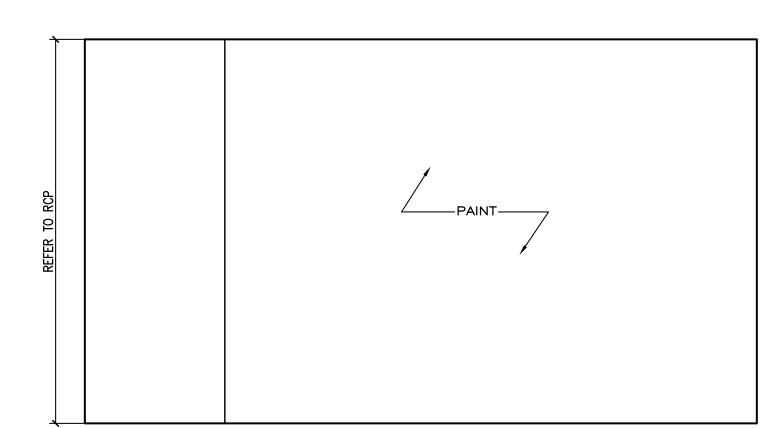

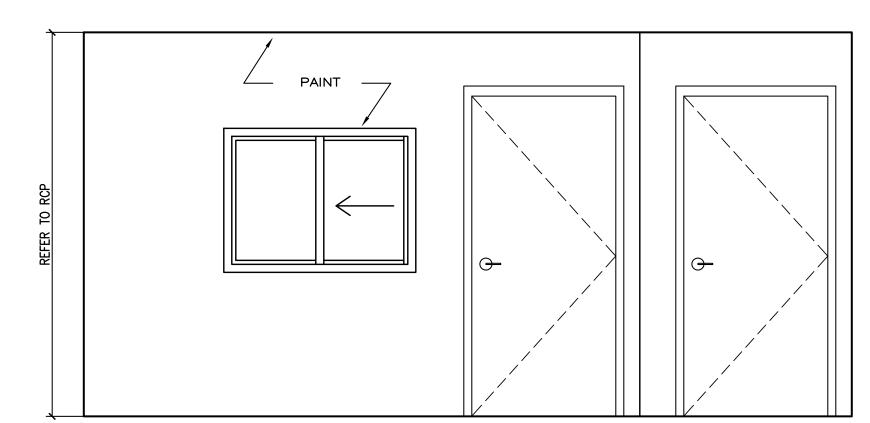

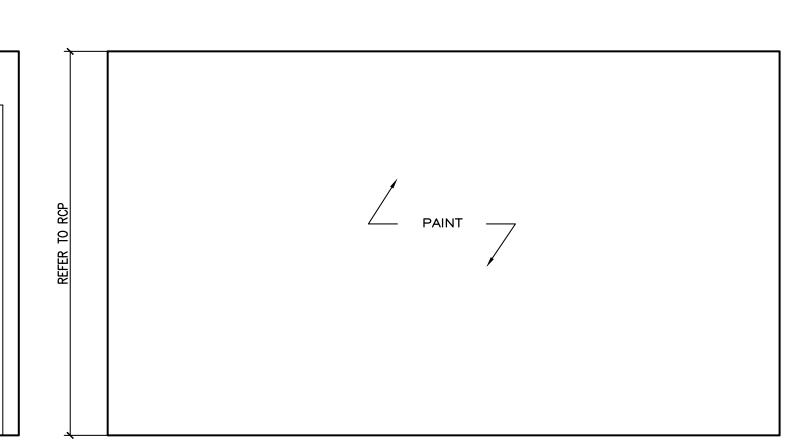

SCALE: 1/2" = 1'-0"

EXAM 6 INT. ELEVATION SCALE: 1/2" = 1'-0"

SURGERY INT. ELEVATION SCALE: 1/2" = 1'-0"

SURGERY INT. ELEVATION SCALE: 1/2" = 1'-0"





PAINT


FREZ.

_MICA CABINET COLOR TO BE SELECTED BY OWNER


_ADJUSTABLE SHELF (TYPICAL)

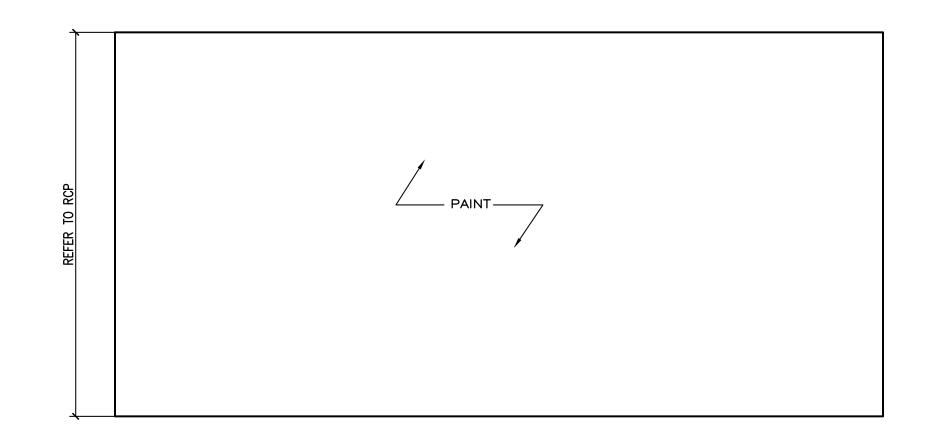


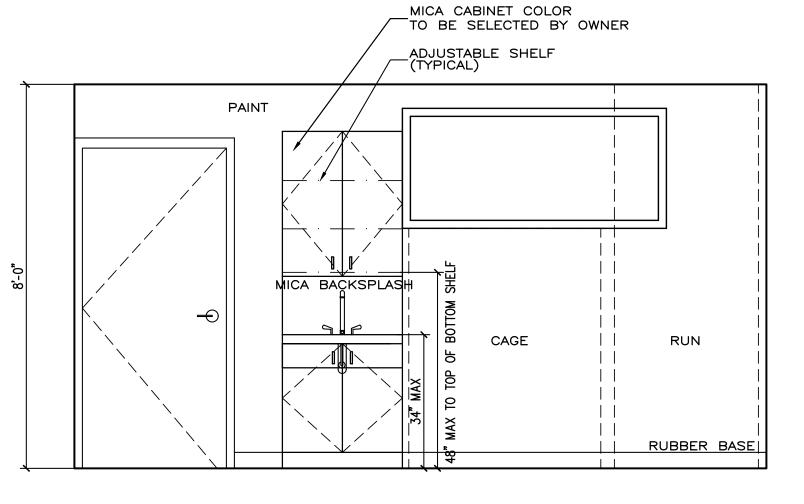


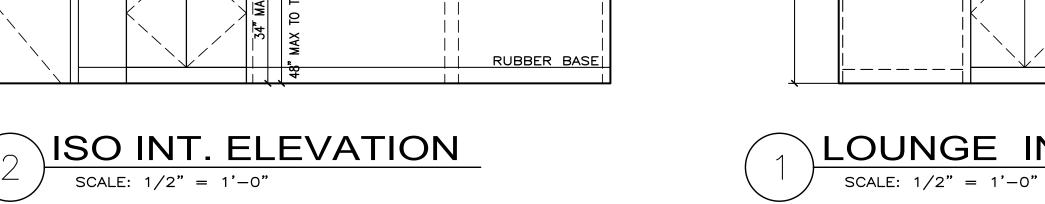



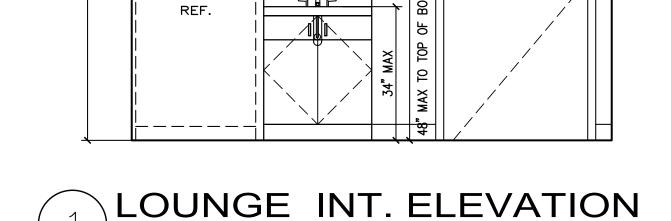

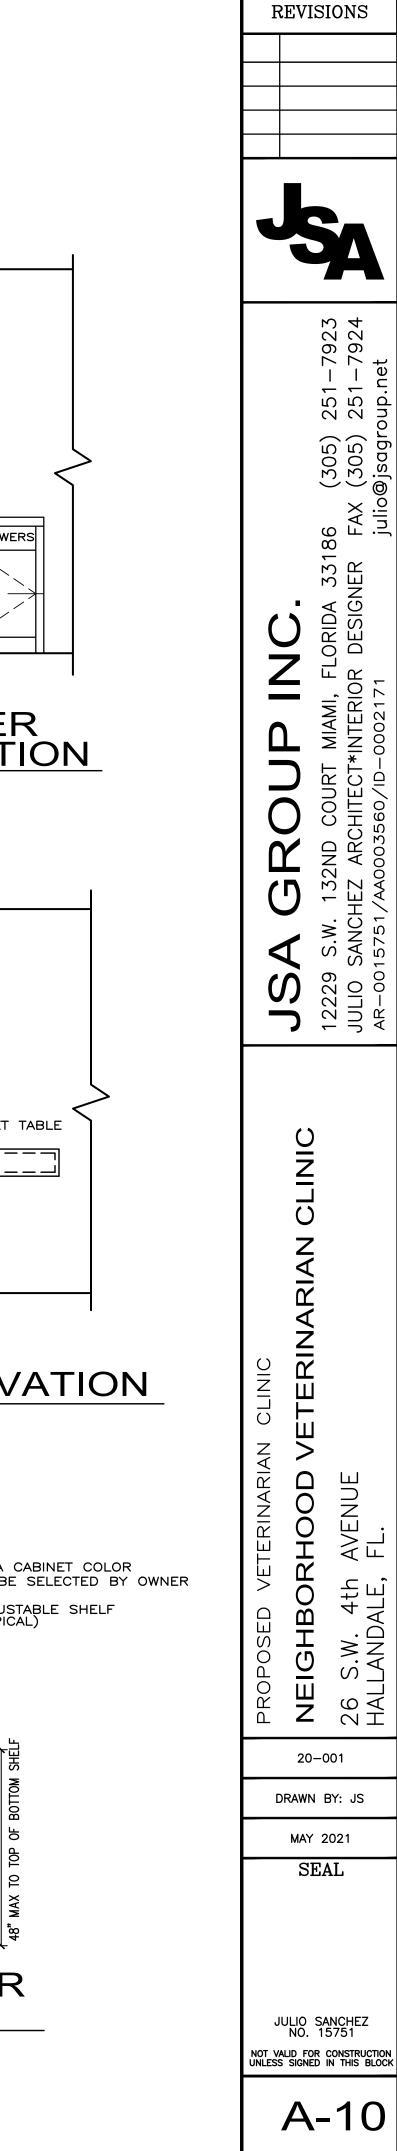


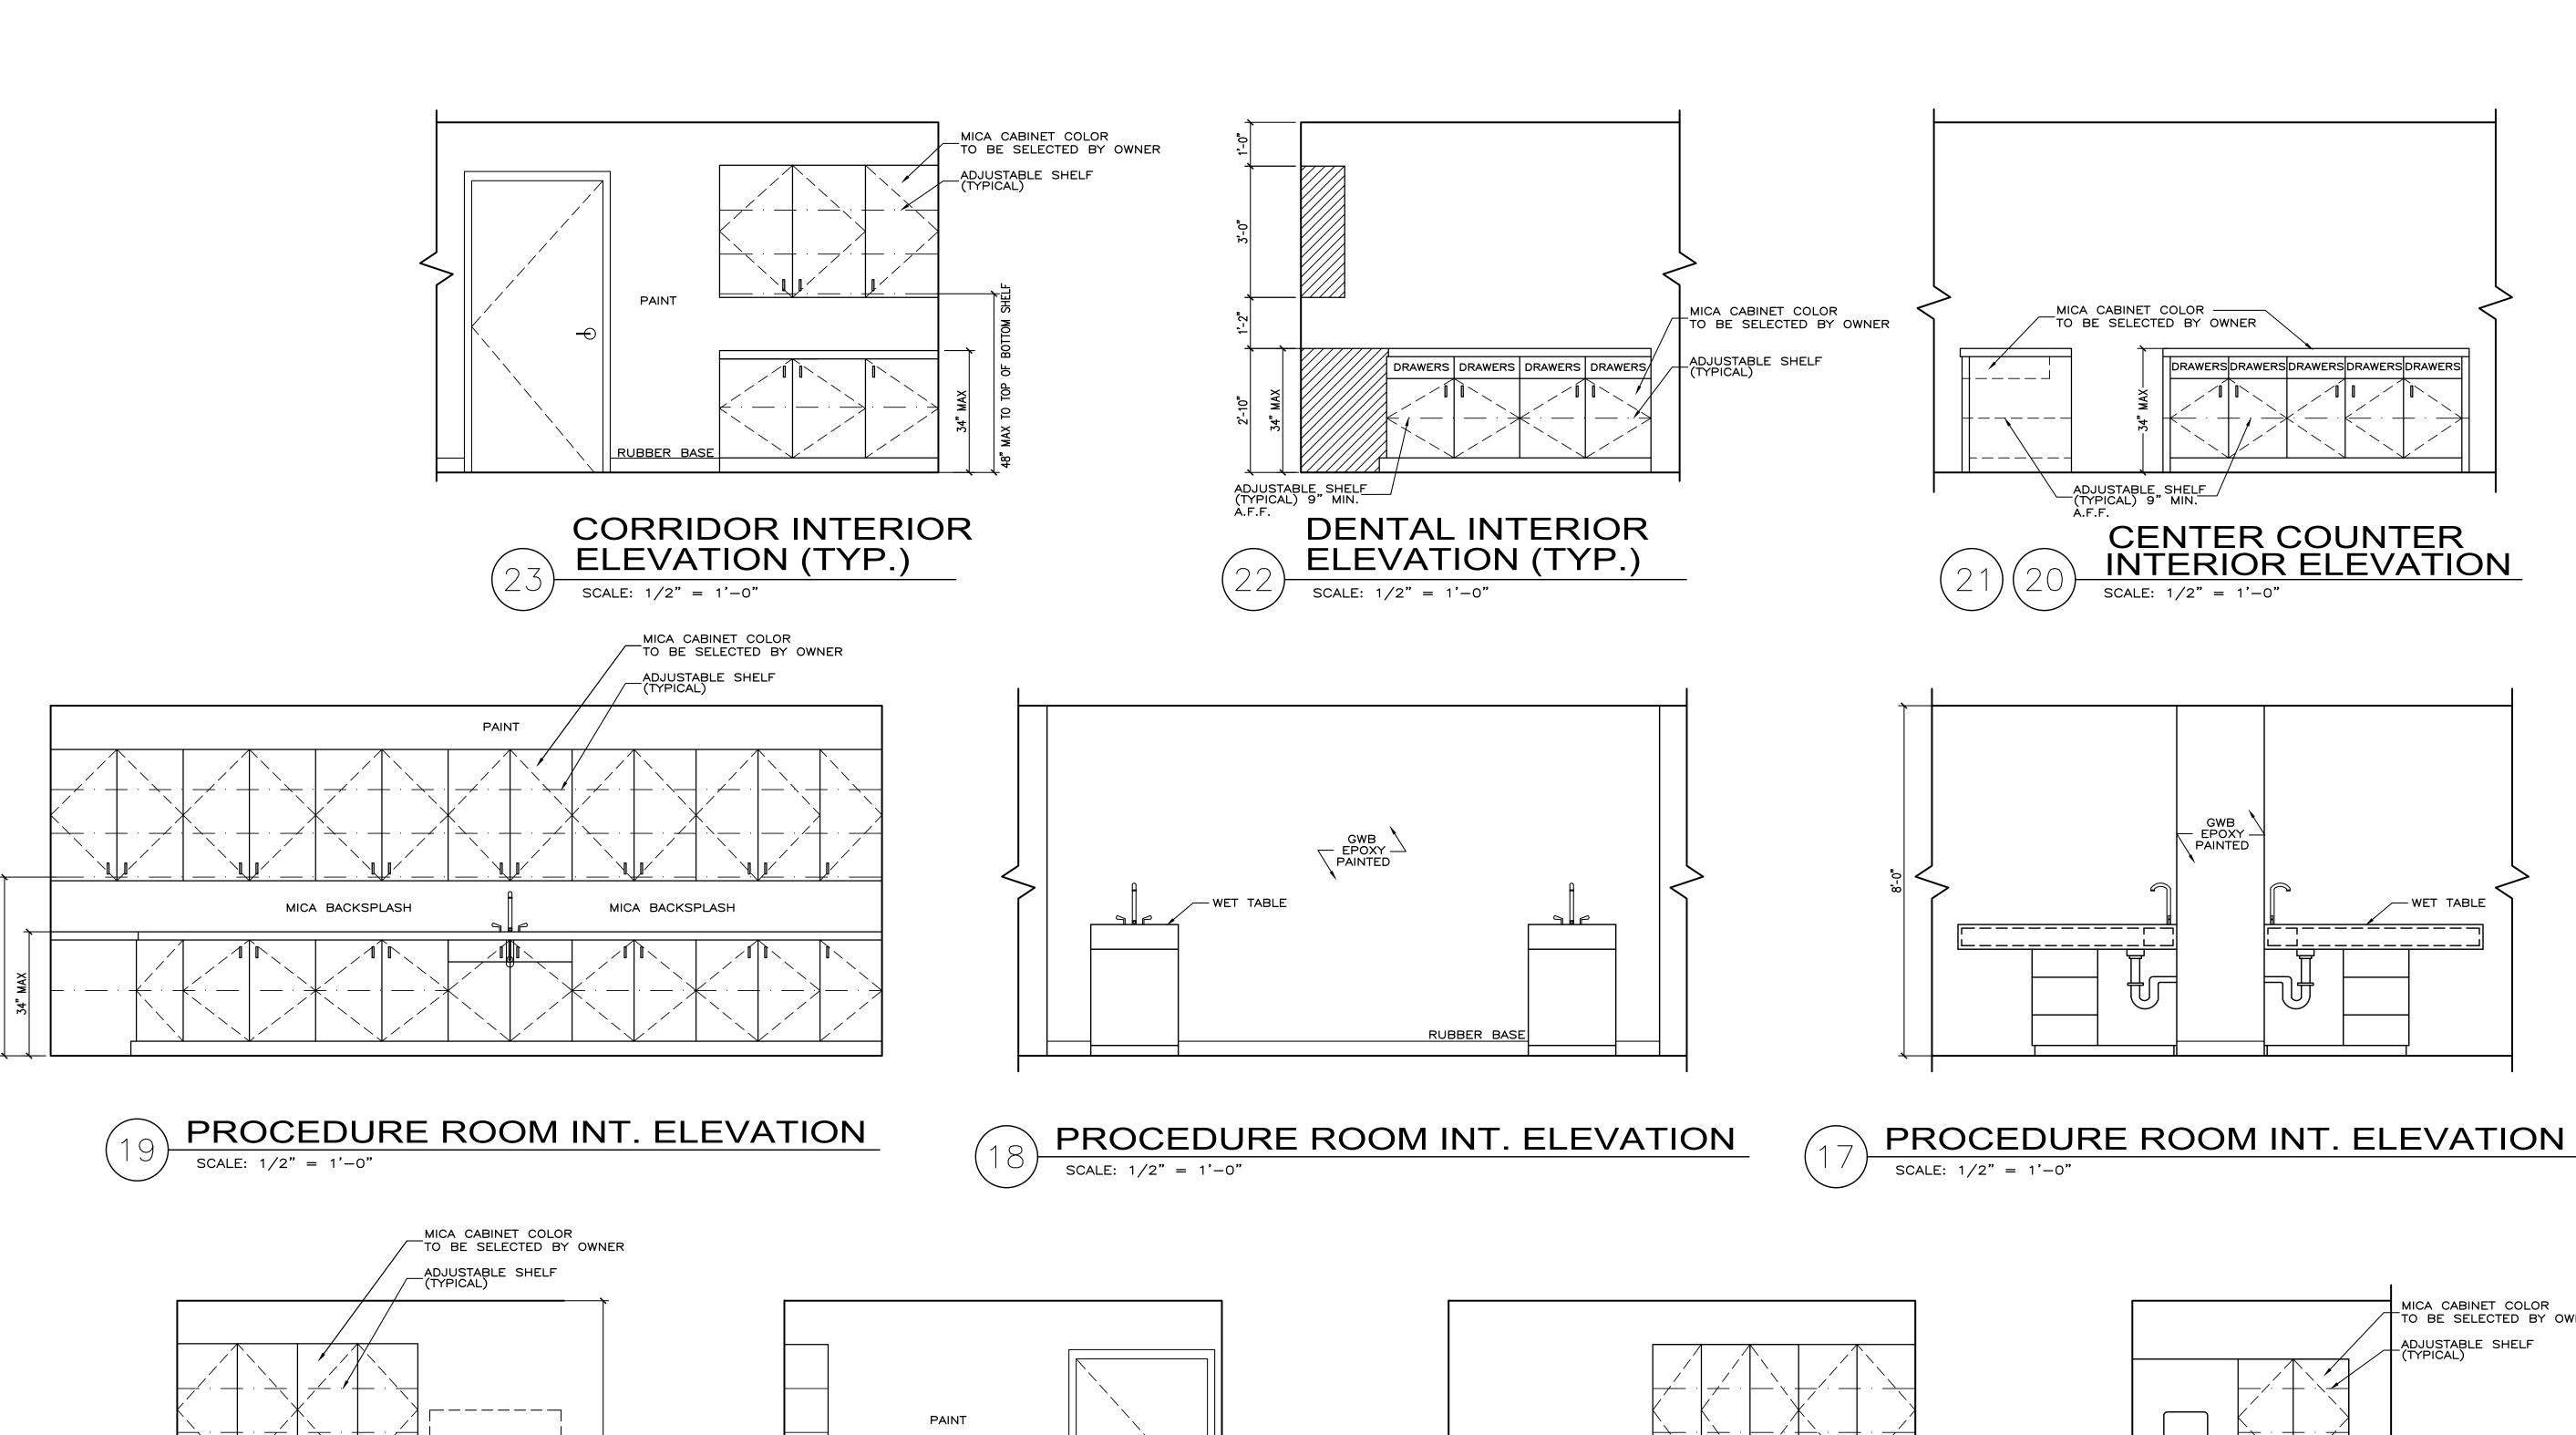




REF.


MICA BACKSPLASH

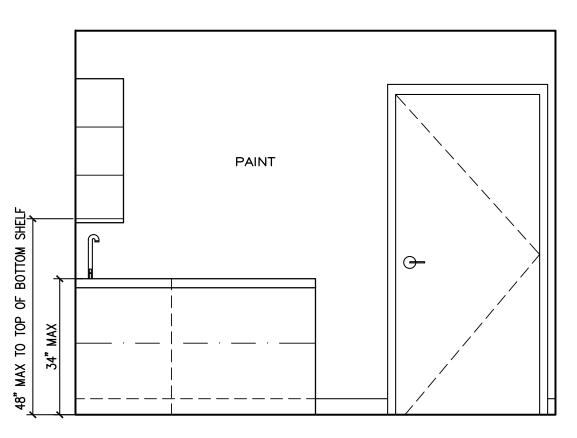



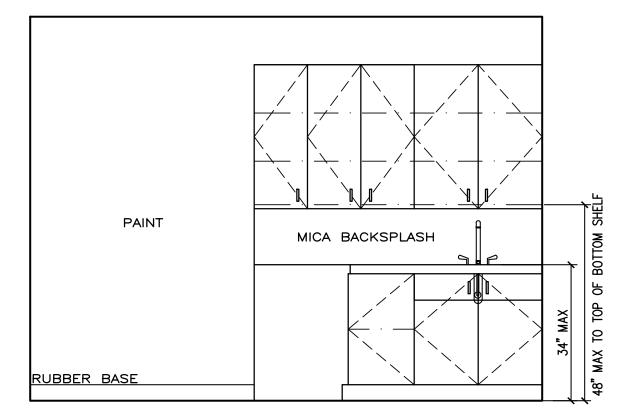



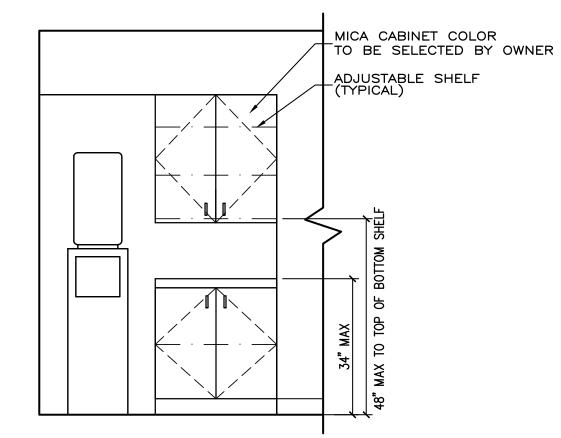

CORR. COUNTER ELEVATION SCALE: 1/2" = 1'-0"

DRAWN BY: JS

JULIO SANCHEZ NO. 15751 NOT VALID FOR CONSTRUCTION UNLESS SIGNED IN THIS BLOCK







SECTION


DRAWERS-


— PLASTIC LAMINATE DESK COUNTER

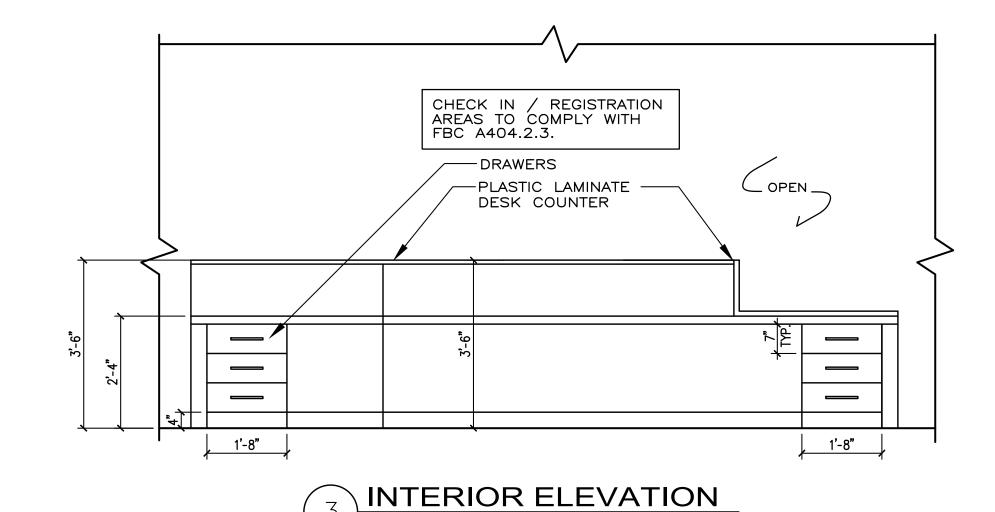

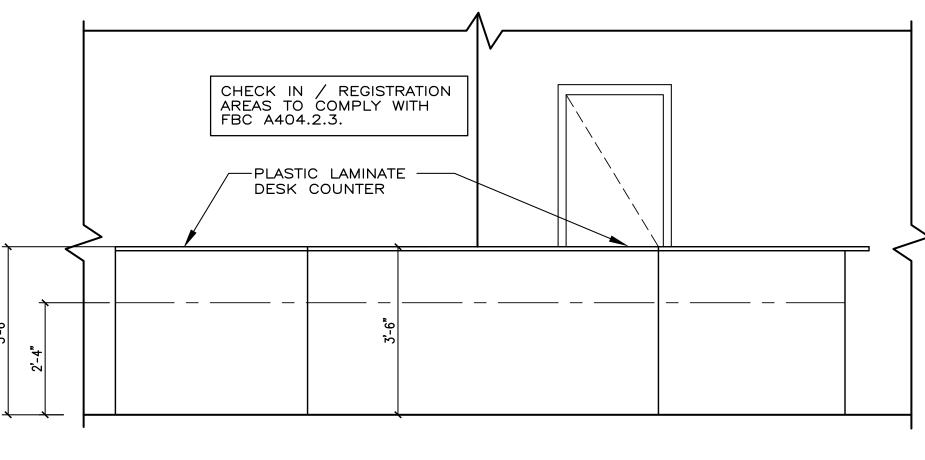

FRONT ELEVATION

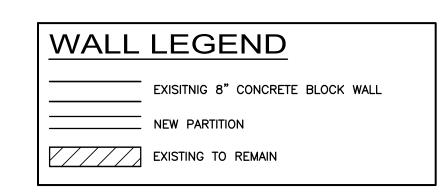

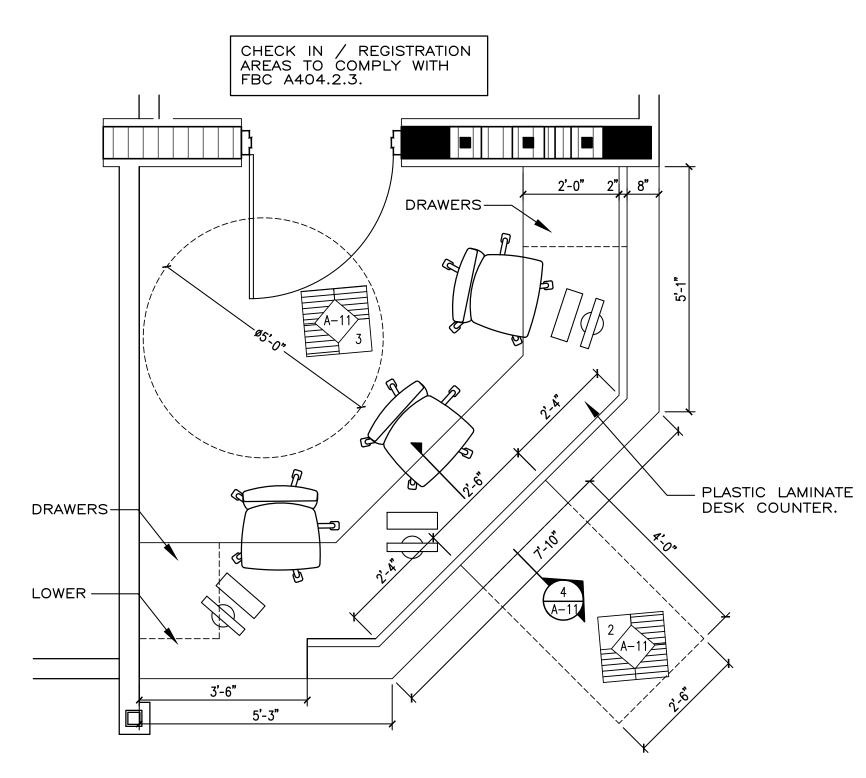


ENLARGED FRONT COUNTER PLAN

20-001 DRAWN BY: JS

MAY 2021

SEAL

JULIO SANCHEZ NO. 15751

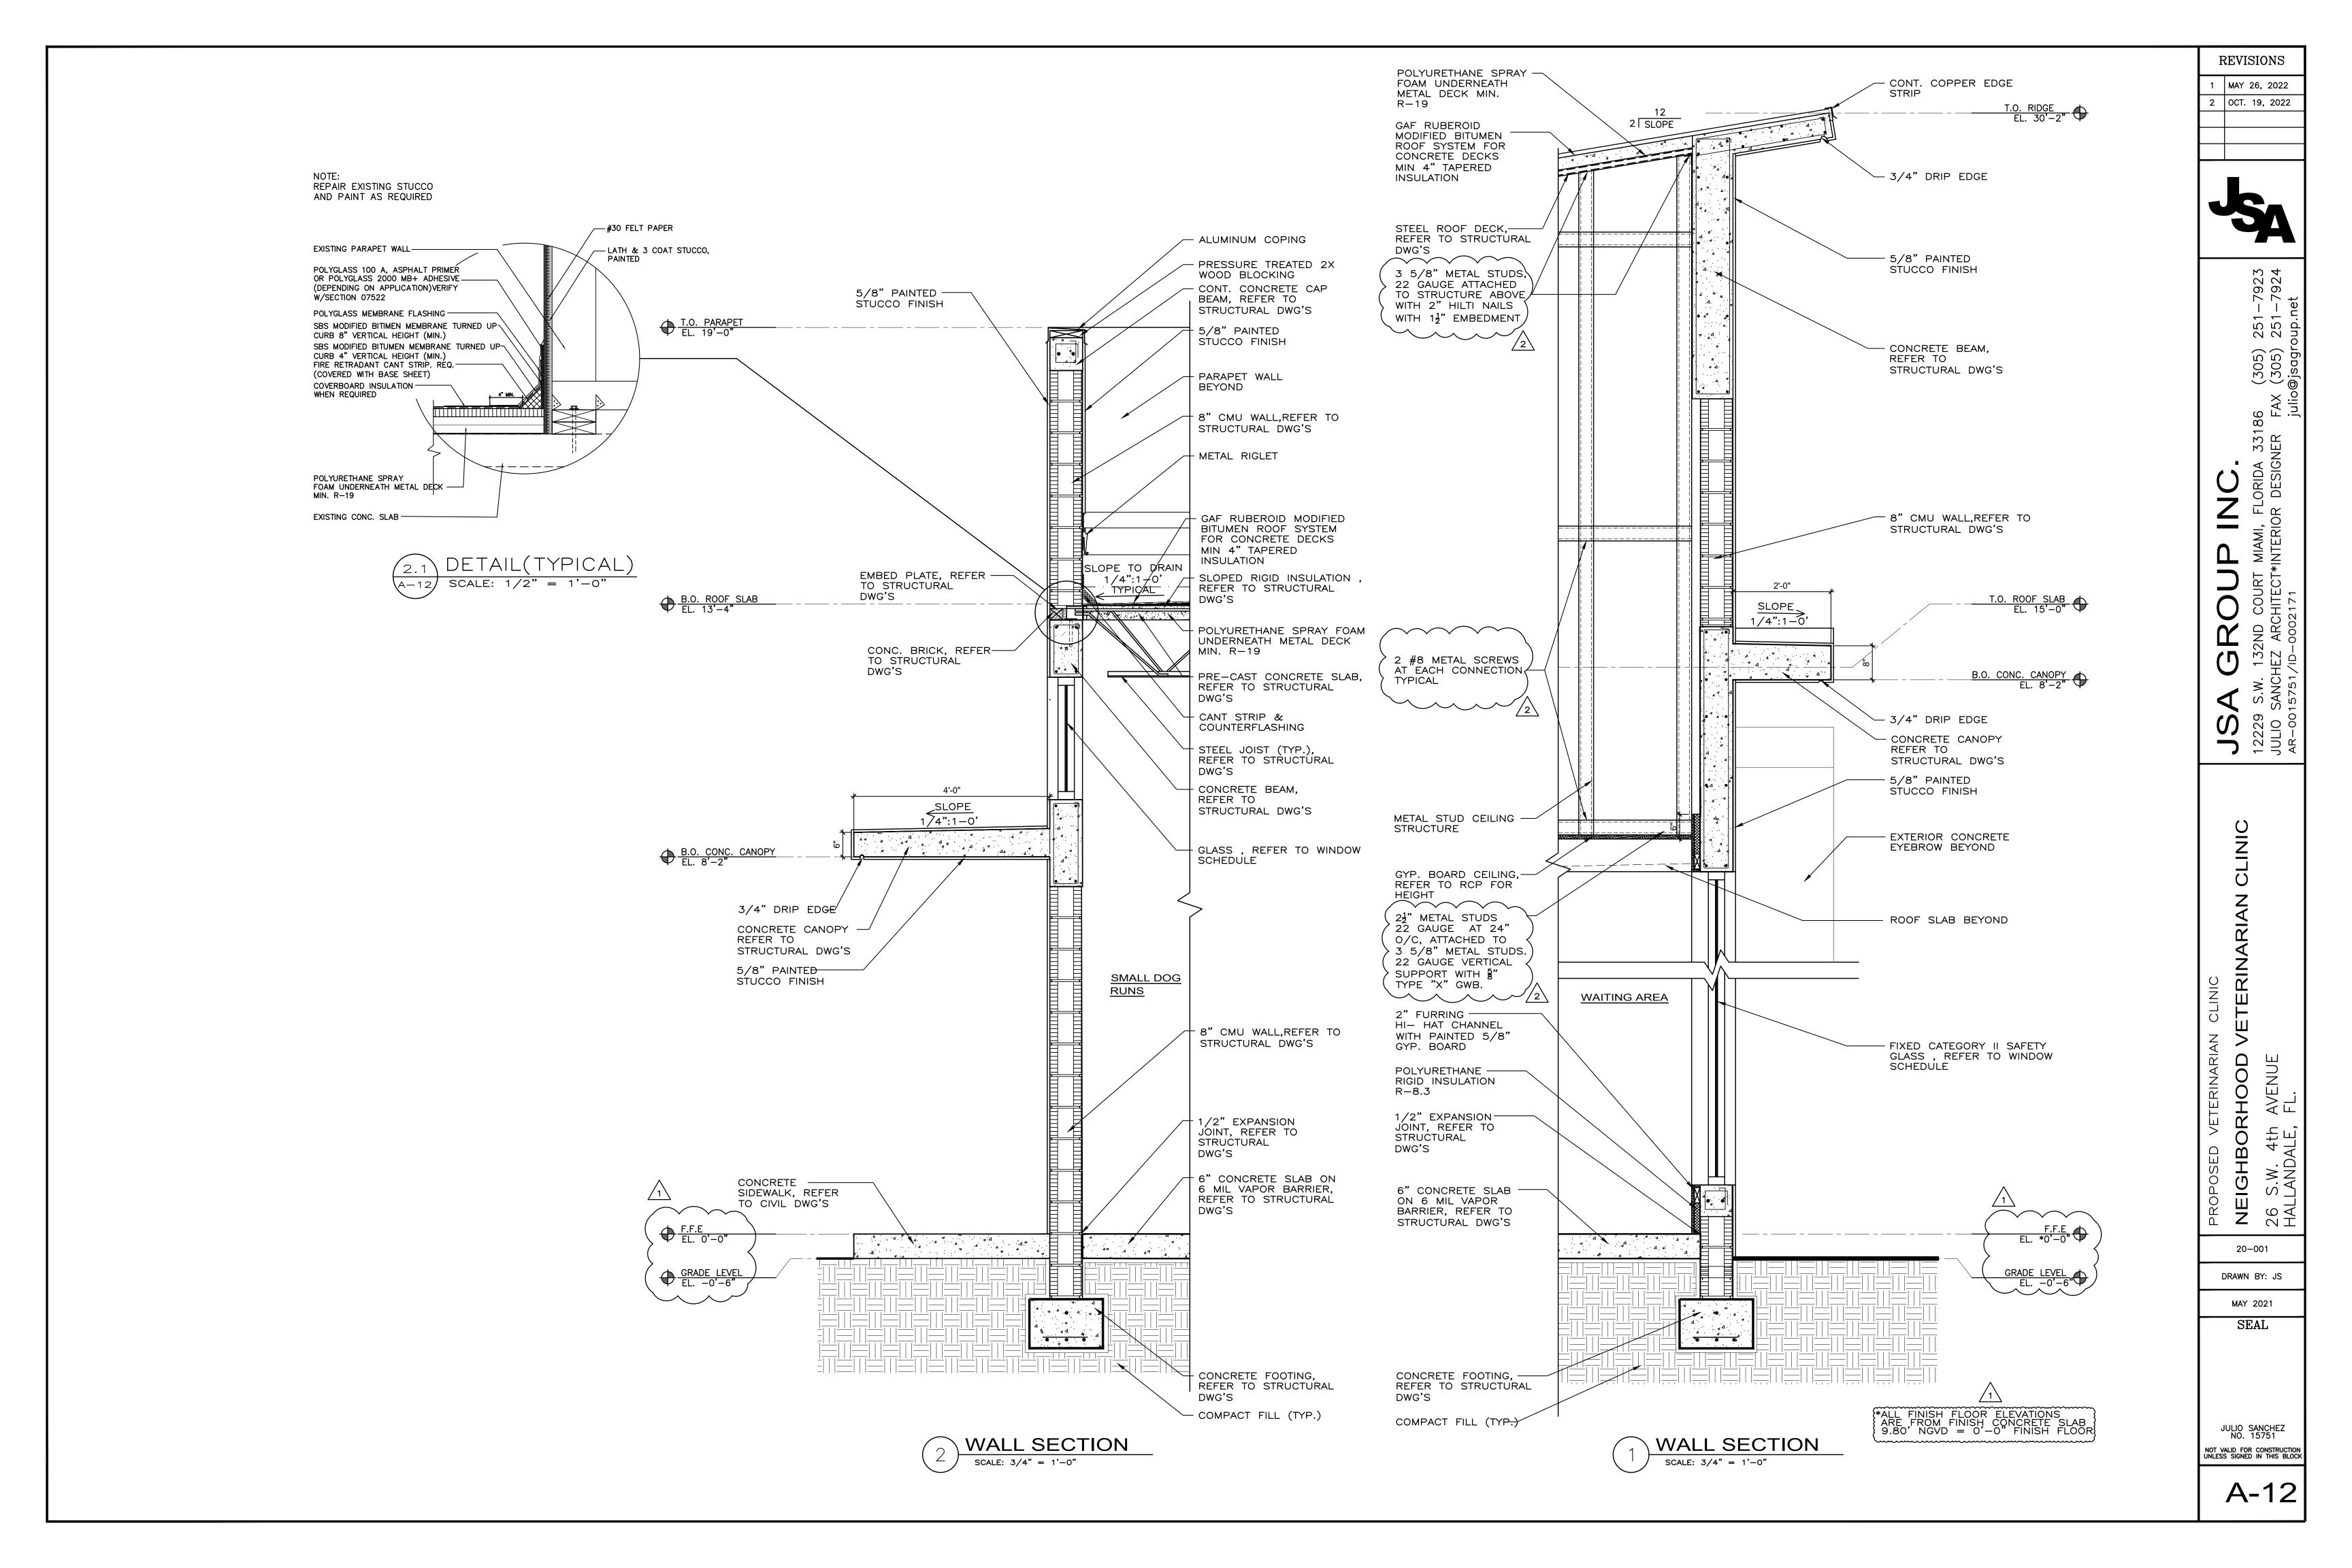

REVISIONS

GENERAL NOTES:

- 2. EXTERIOR DOOR FRAMES TO BE GROUTED WITH CONCRETE OR BLOCK MORTAR. 3. INTERIOR DOOR FRAMES IN STUD PARTITIONS TO BE FILLED WITH GYPSUM BASE

									F	?	S	CHEDULE	
MARK	DIM	ENSIO		DOOR TYPE	LABEL	MATER	IALS		ETAIL	1	i	REMARKS	NOA & EXP. DATE
Σ	W.	Н.	TH.			DOOR	FRAME	THRESHOLD	HEAD	JAMB	1	STOREEDON'T DOOR DOOR AND COMPONENTS TO RECEIVE A BUST INILIBITIVE DRIMED	
(D1)		8'-0"	_	С	_	METAL/IMPACT GLASS	METAL	ALUMINUM			S-1	STOREFRONT DOOR. DOOR AND COMPONENTS TO RECEIVE A RUST INHIBITIVE PRIMER FINISH AT FACTORY. IMPACT GLASS.	
(D2)		8'-0"	_	С	_	METAL/IMPACT GLASS	METAL	ALUMINUM			S-1	DOOR AND COMPONENTS TO RECEIVE A RUST INHIBITIVE PRIMER FINISH AT FACTORY. IMPACT GLASS.	
(D3)			1-3/4"	Α	С	METAL	METAL	ALUMINUM	H-1	J-1	S-1	DOOR AND COMPONENTS TO RECEIVE A RUST INHIBITIVE PRIMER FINISH AT FACTORY.	NOA: NO. 20-0708.03 EXP: 07-16-2025
(D4)	3'-0"	7'-0"	1-3/4"	Α	С	METAL	METAL	ALUMINUM	H-1	J-1	S-1	DOOR AND COMPONENTS TO RECEIVE A RUST INHIBITIVE PRIMER FINISH AT FACTORY.	NOA: NO. 20-0708.03 EXP: 07-16-2025
(D5)	3'-0"	7'-0"	1-3/4"	F	С	METAL	METAL	ALUMINUM	H-1	J-1	S-1	IMPACT RESISTANT STOREFRONT	NOA: NO. 20-1005.11 EXP: 05-05-2022
D6	3'-0"	7'-0"	1-3/4"	F	С	METAL	METAL	ALUMINUM	H-1	J-1	S-1	IMPACT RESISTANT STOREFRONT	NOA: NO. 20-1005.11 EXP: 05-05-2022
D7	3'-0"	7'-0"	1-3/4"	Α	С	METAL	METAL	ALUMINUM	H-1	J-1	S-1	DOOR AND COMPONENTS TO RECEIVE A RUST INHIBITIVE PRIMER FINISH AT FACTORY.	NOA: NO. 20-0708.03 EXP: 07-16-2025
D8	10'-0"	8'-6"	-	D	-	WOOD CEDAR	_	_	-	_	-	DOOR AND COMPONENTS TO RECEIVE A RUST INHIBITIVE PRIMER FINISH AT FACTORY.	
D9	3'-0"	7'-0"	1-3/4"	Α	_	WD SOLID CORE	METAL	_	H-1	J-1	_	SEE DETAIL 1/A-8	NOA: NO. 20-0708.03 EXP: 07-16-2025
(D10)	3'-0"	7'-0"	1-3/4"		С	16GA. STEEL	16GA. STEEL (5-3/4"x2")	ALUMINUM	H-1	J-1	S-1	DOOR AND COMPONENTS TO RECEIVE A RUST INHIBITIVE PRIMER FINISH AT FACTORY.	
(D11)	3'-0"	7'-0"	1-3/4"	E	_	WD/FROSTED GLASS	METAL	_	H-1	J-1	-	CAT. 2 SAFETY GLASS	
D12	3'-0"	7'-0"	1-3/4"	E	_	WD/FROSTED GLASS	METAL	_	H-1	J-1	-	CAT. 2 SAFETY GLASS	
D13	3'-0"	7'-0"	1-3/4"	E	_	WD/FROSTED GLASS	METAL	-	H-1	J-1	-	CAT. 2 SAFETY GLASS	
(D14)	3'-0"	7'-0"	1-3/4"	E	_	WD/FROSTED GLASS	METAL	_	H-1	J-1	_	CAT. 2 SAFETY GLASS	
D15	3'-0"	7'-0"	1-3/4"	E	_	WD/FROSTED GLASS	METAL	_	H-1	J-1	_	CAT. 2 SAFETY GLASS	
(D16)	3'-0"	7'-0"	1-3/4"	Α	С	WD SOLID CORE	METAL	_	H-1	J-1	-	SEE DETAIL 1/A-8	NOA: NO. 20-0708.03 EXP: 07-16-2025
(D17)	-	\vdash	1-3/4"	A	С	WD SOLID CORE	METAL	_	1	J-1	<u> </u>	SEE DETAIL 1/A-8	NOA: NO. 20-0708.03 EXP: 07-16-2025
(D18)	-	\vdash	1-3/4"	A	C	WD SOLID CORE	METAL	_		J-1	-	SEE DETAIL 1/A-8	NOA: NO. 20-0708.03 EXP: 07-16-2025
(D19)			1-3/4"	A	C	WD SOLID CORE	METAL	_		J-1		SEE DETAIL 1/A-8	NOA: NO. 20-0708.03 EXP: 07-16-2025
D20	1		1-3/4"	Α	С	WD SOLID CORE	METAL	_		J-1		SEE DETAIL 1/A-8	
		\vdash	1-3/4"	^				_				<u>'</u>	NOA: NO. 20-0708.03 EXP: 07-16-2025
(D21)	1	\vdash			С	WD SOLID CORE	METAL		-	J-1	-	SEE DETAIL 1/A-8	NOA: NO. 20-0708.03 EXP: 07-16-2025
D22			1-3/4"	E		WD/FROSTED GLASS	METAL	_		J-1	-	CAT. 2 SAFETY GLASS	
D23	.	\vdash	1-3/4"	E	_	WD/FROSTED GLASS	METAL	_	1	J-1		CAT. 2 SAFETY GLASS	
D24			1-3/4"	E	_	WD/FROSTED GLASS	METAL	_		J-1	1	CAT. 2 SAFETY GLASS	
D25		\vdash	1-3/4"	E		WD/FROSTED GLASS	METAL	_		J-1		CAT. 2 SAFETY GLASS	
(D26)		\vdash	1-3/4"	E	_	WD/FROSTED GLASS	METAL	_	1	J-1	-	CAT. 2 SAFETY GLASS	
D27)	3'-0"	7'-0"	1-3/4"	Α	С	WD SOLID CORE	METAL	_	H-1	J-1	_	SEE DETAIL 1/A-8	NOA: NO. 20-0708.03 EXP: 07-16-2025
(D28)	3'-0"	7'-0"	1-3/4"	Α	С	WD SOLID CORE	METAL	_	<u> </u>	_	_	SPECIALTY DOOR SEE DETAIL 1/A-8	NOA: NO. 20-0708.03 EXP: 07-16-2025
D29	3'-0"	7'-0"	1-3/4"	Α	С	WD SOLID CORE	METAL	_	<u> </u>	_	_	SPECIALTY DOOR SEE DETAIL 1/A-8	NOA: NO. 20-0708.03 EXP: 07-16-2025
D30	3'-0"	7'-0"	1-3/4"	Α	С	WD SOLID CORE	METAL	_	_	_	_	SPECIALTY DOOR SEE DETAIL 1/A-8	NOA: NO. 20-0708.03 EXP: 07-16-2025
D31)	3'-0"	7'-0"	1-3/4"	Α	С	WD SOLID CORE	METAL	_	_	_	_	SPECIALTY DOOR SEE DETAIL 1/A-8	NOA: NO. 20-0708.03 EXP: 07-16-2025
D32	3'-0"	7'-0"	1-3/4"	В	С	WD SOLID CORE	METAL	-	-	_		DOUBLE SWING W/ VISION PANEL	
D33	3'-0"	7'-0"	1-3/4"	В	С	WD SOLID CORE	METAL	-	_	_	_	DOUBLE SWING W/ VISION PANEL	
D34	3'-0"	7'-0"	1-3/4"	Α	С	WD SOLID CORE	METAL	_	-	_	_	SPECIALTY DOOR SEE DETAIL 1/A-8	NOA: NO. 20-0708.03 EXP: 07-16-2025
D35	3'-0"	7'-0"	1-3/4"	Α	С	WD SOLID CORE	METAL	_	-	_	-	SEE DETAIL 1/A-8	NOA: NO. 20-0708.03 EXP: 07-16-2025
D36)	3'-0"	7'-0"	1-3/4"	Α	С	WD SOLID CORE	METAL	_	-	_	-	SEE DETAIL 1/A-8	NOA: NO. 20-0708.03 EXP: 07-16-2025
D37	3'-0"	7'-0"	1-3/4"	Α	С	WD SOLID CORE	METAL	_	-	_	-	SEE DETAIL 1/A-8	NOA: NO. 20-0708.03 EXP: 07-16-2025
D38	3'-0"	7'-0"	1-3/4"	Α	С	WD SOLID CORE	METAL	_	 	_	-	SEE DETAIL 1/A-8	NOA: NO. 20-0708.03 EXP: 07-16-2025
D39	3'-0"	7'-0"	1-3/4"	Α	С	WD SOLID CORE	METAL	_	 	_	 	SEE DETAIL 1/A-8	NOA: NO. 20-0708.03 EXP: 07-16-2025
D40	-	\vdash	1-3/4"	В	С	WD SOLID CORE	METAL	_	 	_	-	DOUBLE SWING W/ VISION PANEL	1.5 = - = -
D41)			1-3/4"	В	С	WD SOLID CORE	METAL	_	_	-		DOUBLE SWING W/ VISION PANEL	
D42			1-3/4"	A	C	WD SOLID CORE	METAL	_	 _	_	_	SEE DETAIL 1/A-8	NOA: NO. 20-0708.03 EXP: 07-16-2025
D43)			1-3/4"	A	С	METAL	METAL	ALUMINUM	-	J_1	S-1	DOOR AND COMPONENTS TO RECEIVE A RUST INHIBITIVE PRIMER FINISH AT FACTORY.	NOA: NO. 20-0708.03 EXP: 07-16-2025
			1-3/4"	^	С	METAL	METAL	ALUMINUM				DOOR AND COMPONENTS TO RECEIVE A RUST INHIBITIVE PRIMER FINISH AT FACTORY.	
(D44)	J ³ – 0	[^{′ −} ∪]	1-3/4	A		METAL	METAL	ALUMINUM	1	J-1	3-1	DOOK AND COMPONENTS TO RECEIVE A RUST INHIBITIVE PRIMER FINISH AT FACTORY.	NOA: NO. 20-0708.03 EXP: 07-16-2025

SUBMITTAL NOTE:

CONTRACTOR TO SUMBIT SHOP DRAWINGS (SUBMITTALS) & NOA'S FOR ALL SPECIFICATIONS NOTED ON CONSTRUCTION DOCUMENTS MINIMUM OF (3) COPIES W/SAMPLES.

NOTES:

ALL EXTERIOR DOORS AND WINDOWS SHALL BE FIXED GLASS AND SHALL BE CAT. 2 SAFETY GLASS OR IMPACT GLASS.


ALL APPLICABLE WINDOWS SHALL COMPLY WITH THE FLORIDA BUILDING CODE 2020 WITH REGARDS TO EGRESS REQUIREMENTS AND MINIMUM CLEAR OPENINGS SIZES.

ALL OTHER GLASS(UNLESS NOTED OTHERWISE) SHALL BE STANDARD GREY TINT 1 THICKNESS.

CONTRACTOR TO PROVIDE PRODUCT APPROVAL AND SEPARATE PERMIT FOR WINDOWS AND DOORS.


COORDINATE HARDWARE SETS WITH OWNER. ALL WALLS TO BE PAINTED.

THESE DOCUMENT ARE IN COMPLIANCE WITH THE FBC 2020.

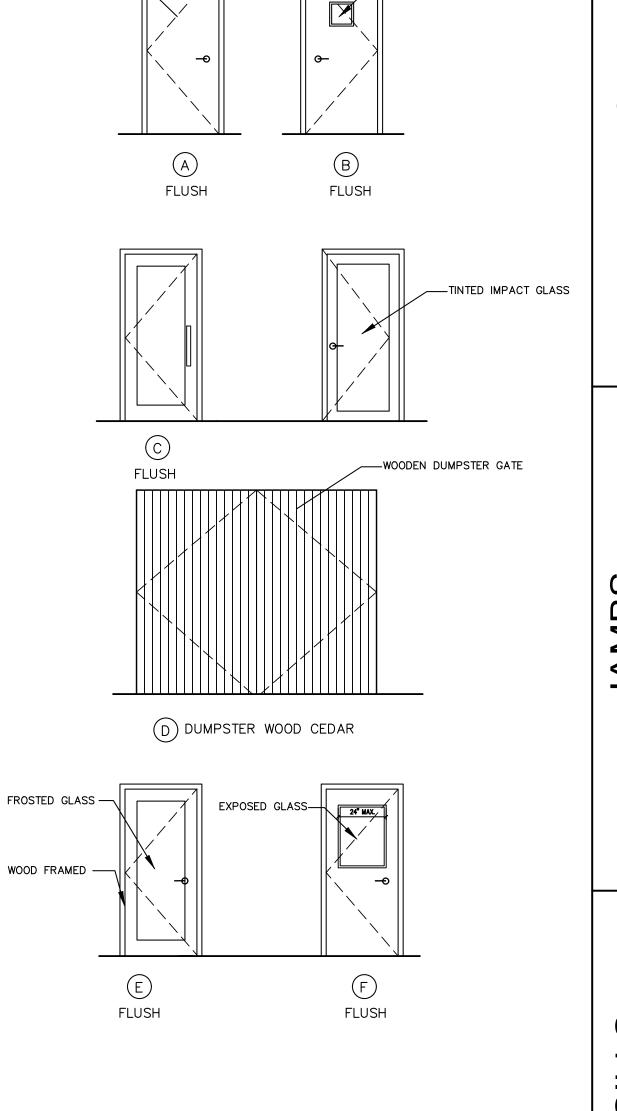

12 X 12 VISION PANEL

SOLID WOOD CORE-

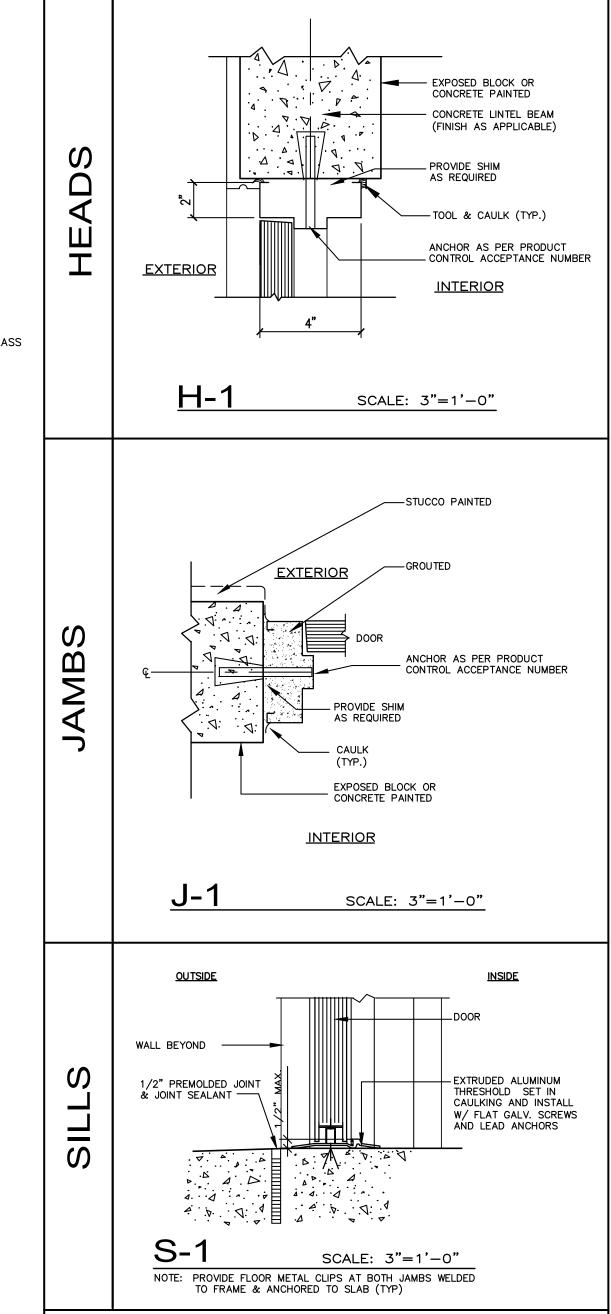

1. ALL EXTERIOR AND INTERIOR DOOR FRAMES TO BE FULLY GROUTED.

COAT PLASTER BEFORE INSTALLATION.

NEIGHBORHOC 26 S.W. 4th AVEN HALLANDALE, FI

20-001

DRAWN BY: JS

MAY 2021

SEAL

JULIO SANCHEZ NO. 15751

ALL EXTERIOR DOORS AND WINDOWS SHALL BE IMPACT RESISITANT. ALL APPLICABLE WINDOWS SHALL COMPLY WITH FLORIDA BLDG. CODE 2020 WITH REGARDS TO EGRESS REQUIREMENTS AND MINIMUM CLEAR OPENING SIZES.

ALL OTHER GLASS (UNLESS NOTED OTHERWISE) SHALL BE STANDARD GREY TINT 1/8" THICKNESS.

CONTRACTOR TO PROVIDE PRODUCT APPROVAL AND SEPARATE PERMIT FOR WINDOWS & DOORS. COORDINATE HARDWARE SETS W/OWNER.

ALL WALLS TO BE PAINTED. THESE DOCUMENTS ARE IN COMPLIANCE WITH THE FBC

G.C. IS TO PROVIDE SPECIFIED WINDOWS & DOORS SHOP DRAWINGS

	WI	NDO	OW SC	H E C	UL	E		
MARK	CODE	QUANTITY	TYPE	WIDTH	HEIGHT	REMARKS	DESCRIPTION	LOCATION
Α	CUSTOM	2	FIXED GLASS	6'-6"	6'-10"	STOREFRONT/IMPACT GLASS		EXTERIOR
В	CUSTOM	6	FIXED GLASS	4'-9"	6'-0"	STOREFRONT/IMPACT GLASS		EXTERIOR
С	CUSTOM	2	FIXED GLASS	4'-9"	6'-10"	STOREFRONT/IMPACT GLASS		EXTERIOR
D	CUSTOM	4	FIXED GLASS	11'–8"	2'-2"	STOREFRONT/IMPACT GLASS		EXTERIOR
E	CUSTOM	4	FIXED GLASS	4'-9"	6'-6"	STOREFRONT/IMPACT GLASS		EXTERIOR
F	CUSTOM	2	FIXED GLASS	4'-9"	4'-8"	STOREFRONT/IMPACT GLASS		EXTERIOR
G	CUSTOM	2	FIXED GLASS	5'-0"	5' – 0"	STOREFRONT/IMPACT GLASS	2'-6" DIAMETER	EXTERIOR
Н	CUSTOM	2	FIXED GLASS	9'-8"	2'-2"	STOREFRONT/IMPACT GLASS		EXTERIOR


WINDOW NOTES:


ALL APPLICABLE WINDOWS SHALL COMPLY WITH FLORIDA BUILDING CODE 2010 WITH REGARDS TO EGRESS REQUIREMENTS AND MINIMUM CLEAR OPENING SIZES. ALL FIXED GLASS SHALL CAT 2 SAFETY GLASS.


ALL OTHER GLASS (UNLESS NOTED OTHERWISE) SHALL BE STANDARD GREY TINT.

SUBMITTAL NOTE:

CONTRACTOR TO SUMBIT SHOP DRAWINGS (SUBMITTALS) & NOA'S FOR ALL SPECIFICATIONS NOTED ON CONSTRUCTION DOCUMENTS MINIMUM OF (3) COPIES W/SAMPLES.

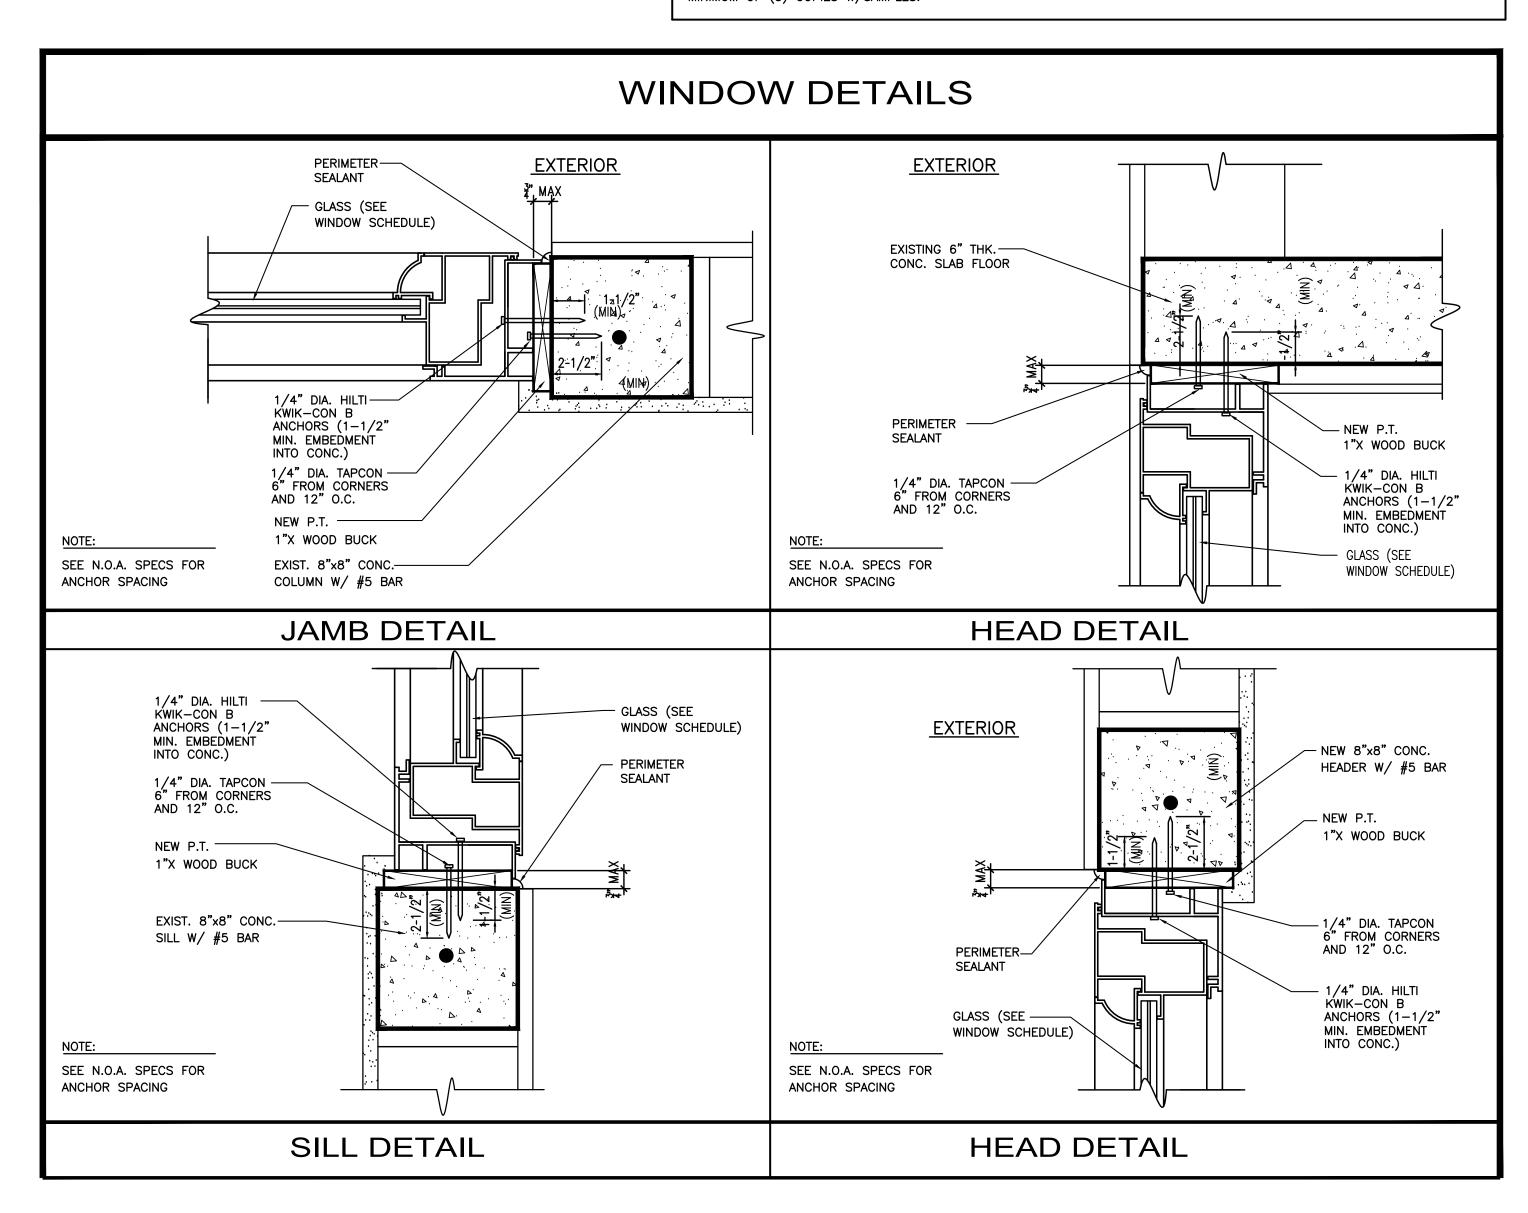

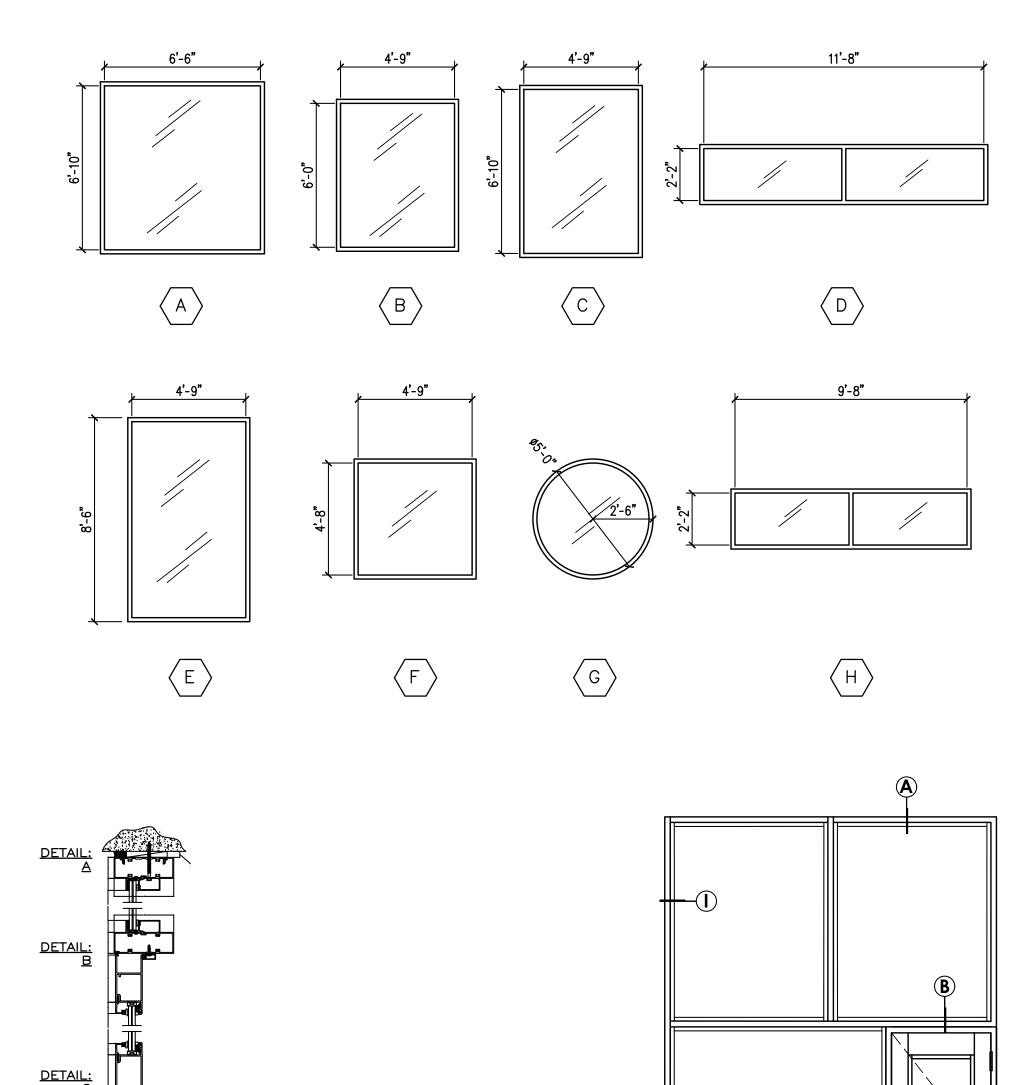

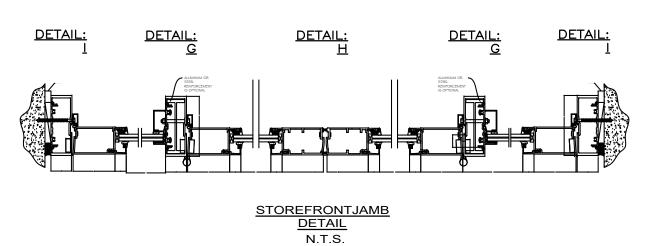

HEAD / SILL DETAIL N.T.S.



STOREFRONT DOOR TYPE: MATERIAL: ALLUMINUM

TO MATCH EXISTING FINISH:

EXTERIOR USE:

.7923 .7924

REVISIONS

251— 251—


AHOOD AVENUE FL.

20-001

DRAWN BY: JS

JANUARY 2021 SEAL


JULIO SANCHEZ NO. 15751

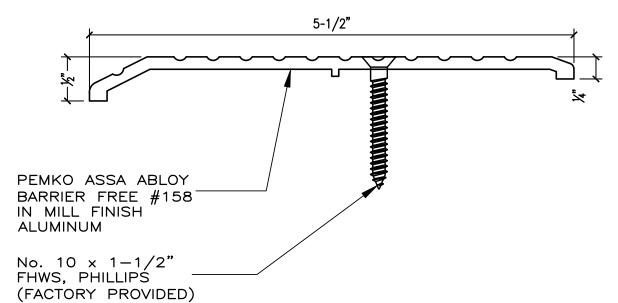

≥ (*) OR APPROVED EQUAL





N.T.S.

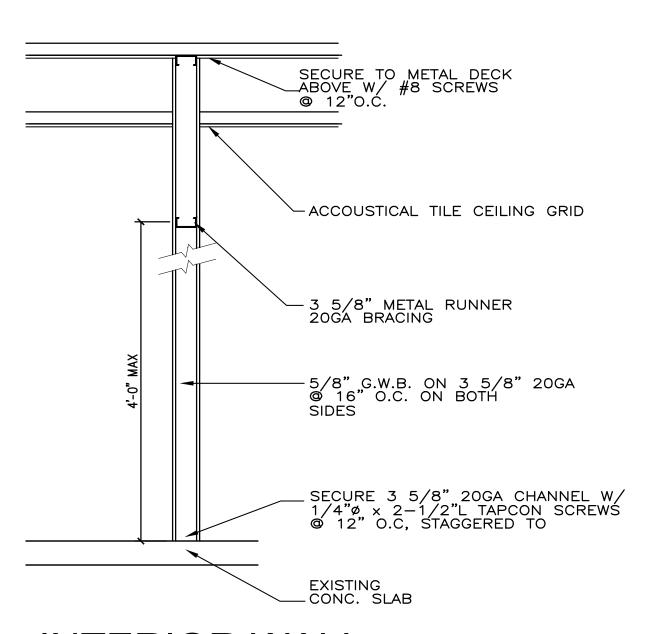

INTERIOR WALL SECTION (TYPICAL) SCALE: 3/4" = 1' - 0" A - 9

	FIRE EXTINGUISHERS SCHEDULE								
MARK	DESCRIPTION	LOCATION	COMMENTS						
F.E.1	"POTTER ROEMER" OR APPROVED EQUAL TYPE: ABC TYPE— "2A-10 B, C" RATED CABINET ENCLOSED. "ALTA' SERIES, MODEL # 7012-F-HB, SEMI RECESSED MOUNTING HIGHT: 60" ADOVE FINISHED FLOOR.	RESTROOMS, OFFICES MULTIPURPOSE ROOM LOBBY/ ENTRY							

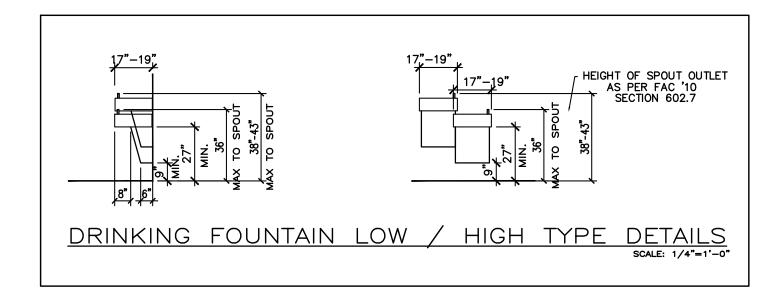

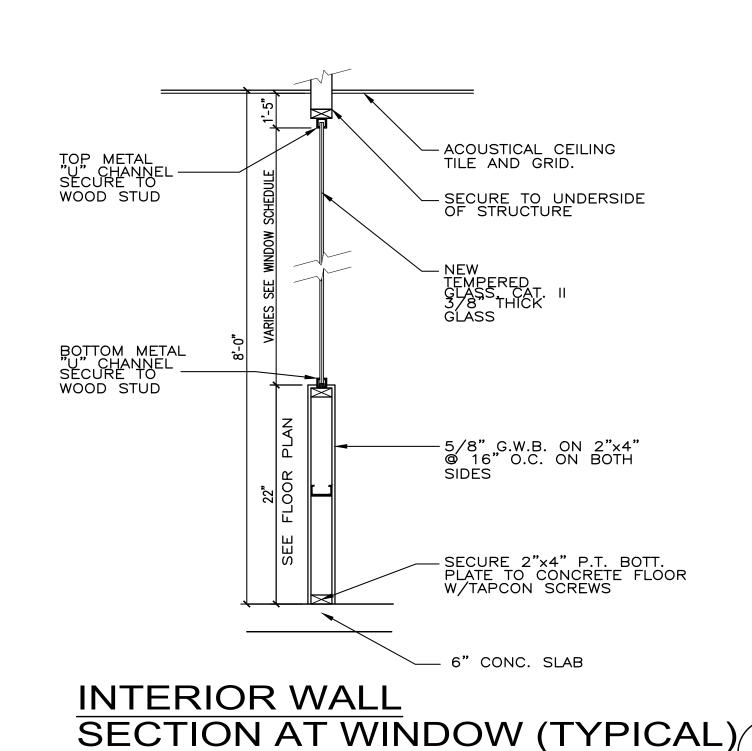

SIGNAGE SCHEDULE |SIGN # |FLOOR # |ROOM # |ROOM NAME MAIN TEXT TYPE COMMENTS #001 RESTROOM 001 001 |RESTROOM UV, CHEMICAL, 002 GROOMING & FOOD PREP. #002 GROOMING & FOOD PREP. 002 ABRASION & #003 GR MOISTURE 003 003 Α EXAM ROOM #004 EXAM ROOM 004 004 RESISTANT(GLOW #005 EXAM ROOM 005 005 EXAM ROOM 2 IN THE DARK) #006 EXAM ROOM SEMI-006 006 EXAM ROOM 3 #007 HALLWAY RIGID PVC 007 007 HALLWAY PLASTIC 14"x10" EXAM ROOM 4 800 #008 EXAM ROOM 800 SIGNS 009 EXAM ROOM 5 #009 EXAM ROOM 009 AS PER FBC 010 010 EXAM ROOM 6 #010 EXAM ROOM 2020 011 RESTROOM #011 RESTROOM 011 ACCESSIBILITY 7th 012 SURGERY #012 SURGERY ROOM 012 EDITION, SECTION #013 OFFICE 013 | 1 OFFICE 013 703.5.1 014 | 1 LOUNGE 1#014 LOUNGE


SIGNAGE NOTES:

 CONTRACTOR SHALL SUBMIT SHOP DRAWINGS AND SCHEDULE FOR APPROVAL. NO SIGNS SHALL BE MANUFACTURED W/OUT MDCPS

014

- 2. ROOM TEXT MUST BE VERIFIED WITH MDCPS PRIOR TO MANUFACTURING OF SIGN.
- 3. CONTRACTOR MAY INCREASE SIGN WIDTH IN 1" INCREMENTS UP TO MAX. SHOWN ON SIGN TYPE, TO ACCOMODATE LONG TITLES.
- 4. UNLESS SPECIFICALLY NOTED, ALL SIGNS TO BE MOUNTED ON THE LATCH SIDE OF THE DOOR. CONSULT A/E AND SCHOOL BOARD WHERE MOUNTING SPACE IS LIMITED.

NOTE: CONTRACTOR SHALL PROVIDE A UNIQUE EVACUATION PLAN FOR EACH STUDENT OCCUPIED AREA. PLAN SHALL SHOW ROOM NUMBERS, EXIT ROUTE AS A DASHED LINE, A LARGE ARROW AT THE PRIMARY EXIT (NEAREST TO CLASSROOM) AND SMALLER ARROWS AT SECONDARY EXITS (NEXT CLOSEST TO CLASSROOM). PLAN SHALL BE ORIENTED RELATIVE TO USER POSITION WHILE FACING SIGN.

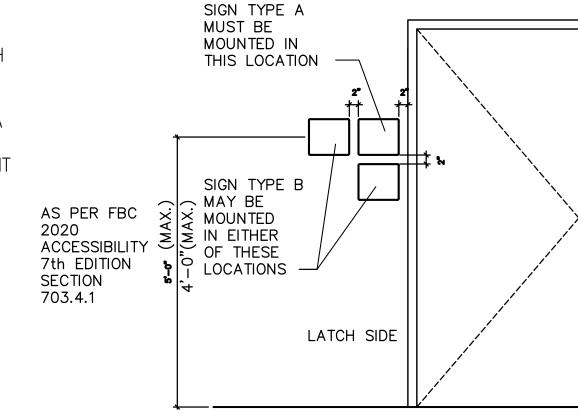


WALL MOUNTING

HIERARCHY:


IN LOCATIONS WITH MULTIPLE SIGNS, THE HIERARCHY IS AS FOLLOWS: ROOM NAME / NUMBER
BUILDING NAME / NUMBER
REGULATORY SIGNAGE
A. FIRE EXTINGUISHER SIGNAGE

INFORMATIONAL SIGNAGE

A. VISITOR DIRECTIONAL SIGNAGE B. NON-SMOKING FACILITY SIGNAGE

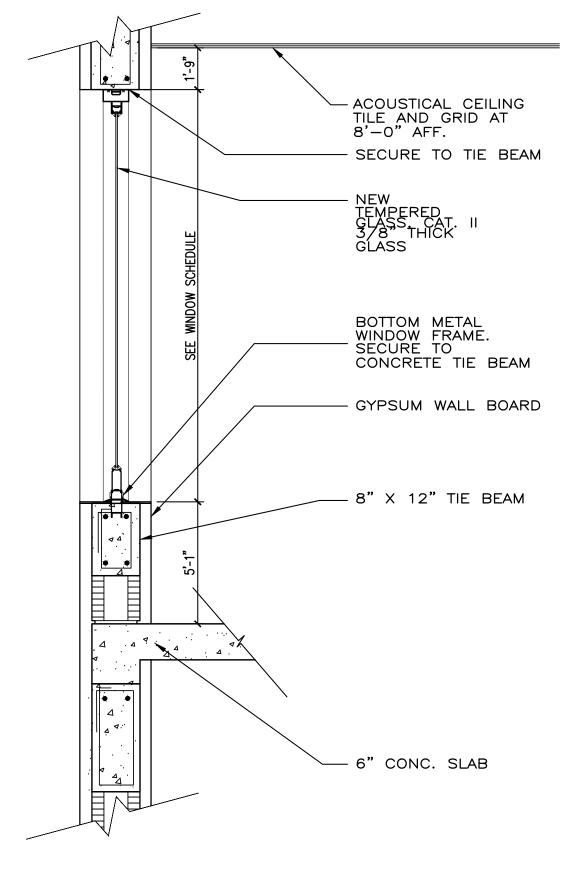



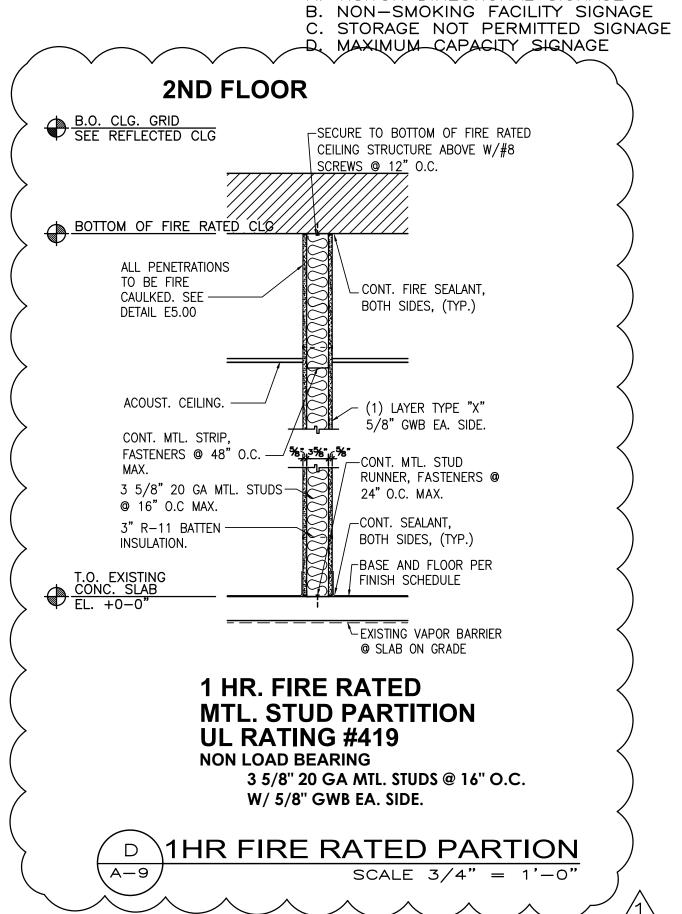

REVISIONS 1 08/04/2021

7923 7924 251— 251— 305)

86 F,

AVENUE FI

20-001

DRAWN BY: JS MAY 2021


SEAL

JULIO SANCHEZ NO. 15751 NOT VALID FOR CONSTRUCTION UNLESS SIGNED IN THIS BLOCK

4
2 4

Luminaire Schedule												
Symbol	Qty	Label	Arrangement	Total Lamp Lumen	sLLF	Description						
+	3	EAL2-70W-40K-4M IES_1	SINGLE	9339.2	0.950	LUMINOSO 70 Watts LED Fixture						
	2	EAL2-40W-40K-3M IES	SINGLE	5469.6	0.950	LUMINOSO 40 Watts LED Fixture						

Calculation Summary										
Label	CalcType	Units	Avg	Max	Min	Avg/Min	Max/Min			
Parking Area 2	Illuminance	Fc	3.00	6.7	1.1	2.73	6.09			

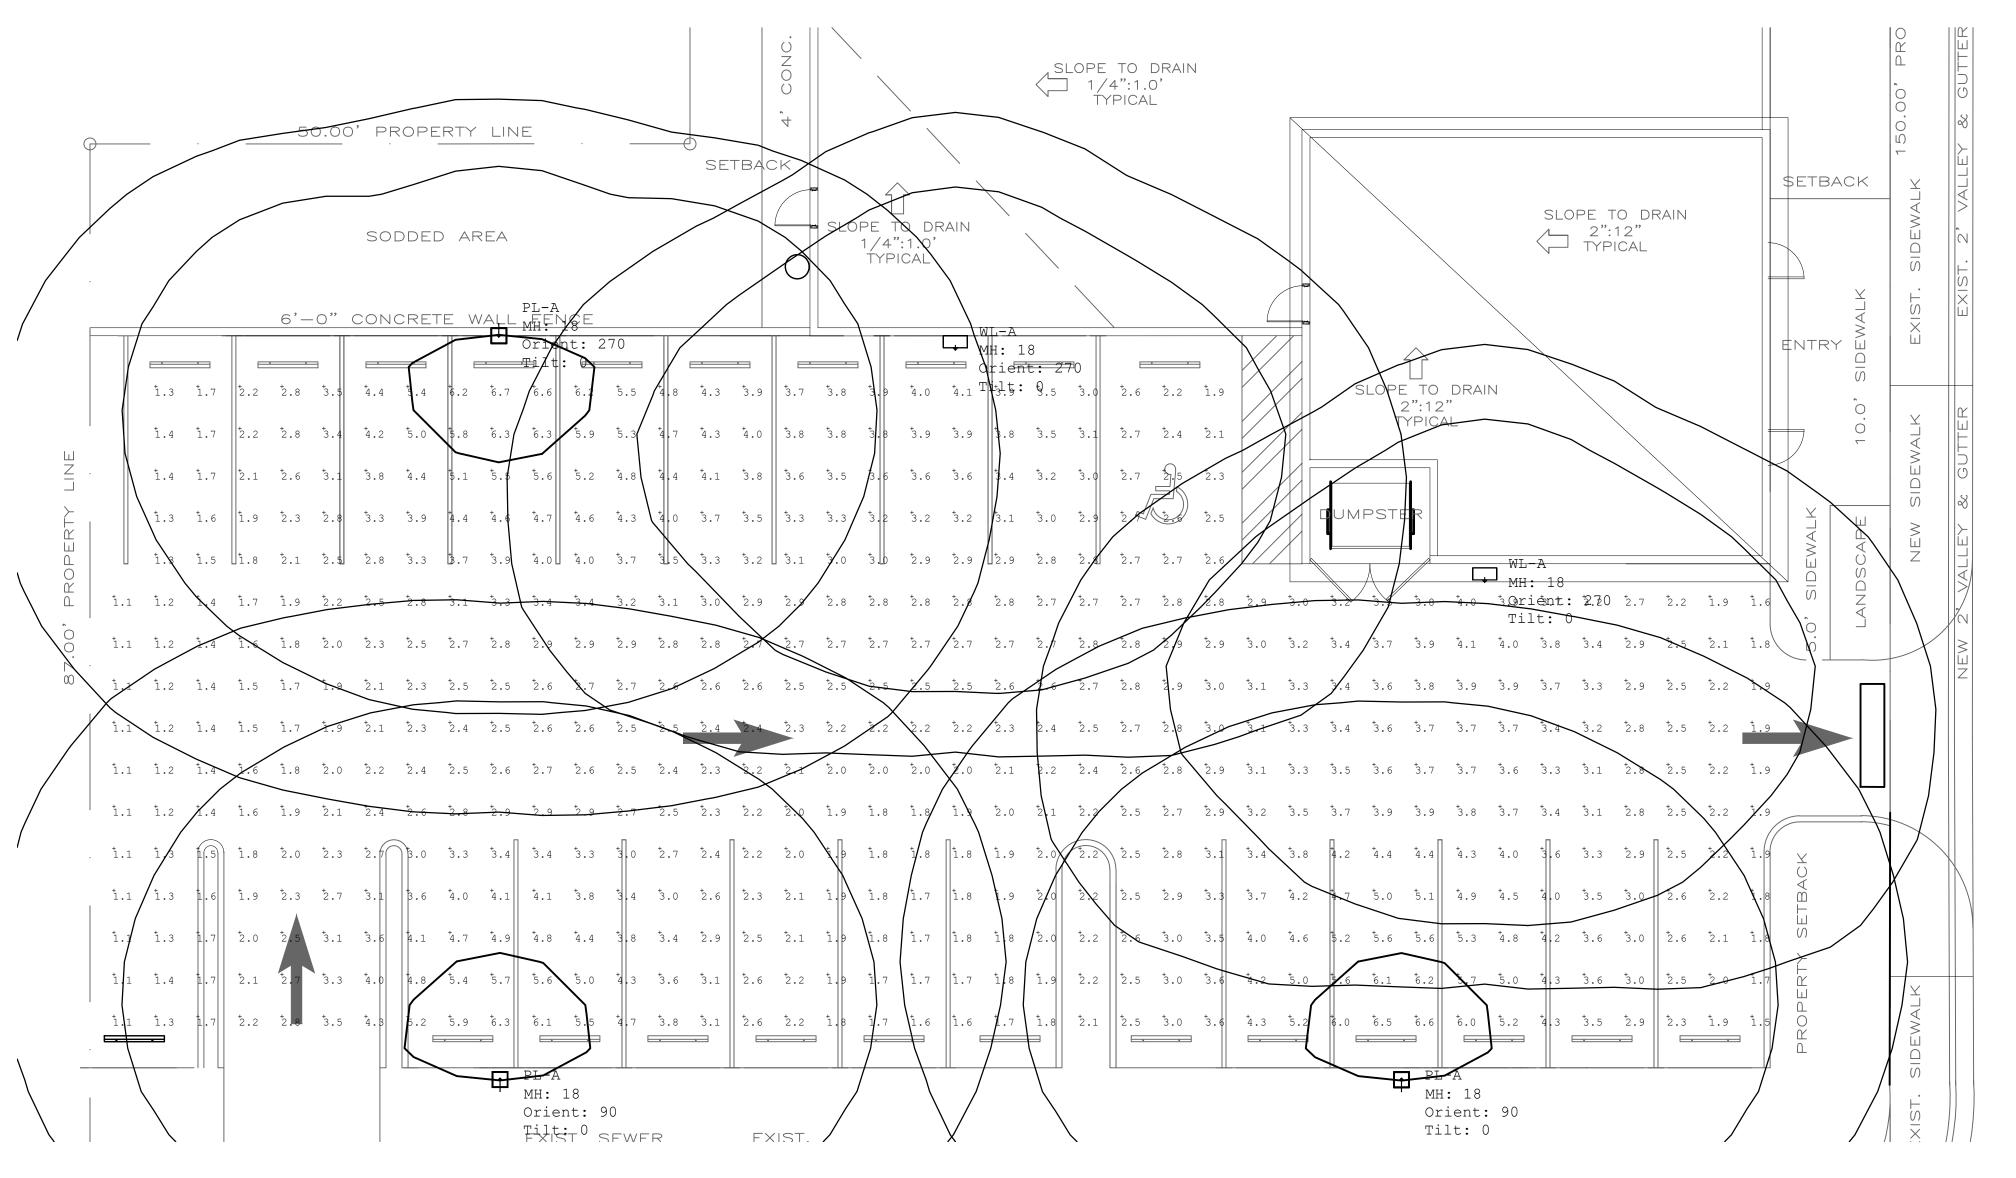

1 PROPOSED PARKING PHOTOMETRIC PLAN

DRAWN BY: JS


(MEP TL 21-39)

JANUARY 2021

PH-1

MAP OF BOUNDARY, TOPOGRAPHIC & TREE SURVEY



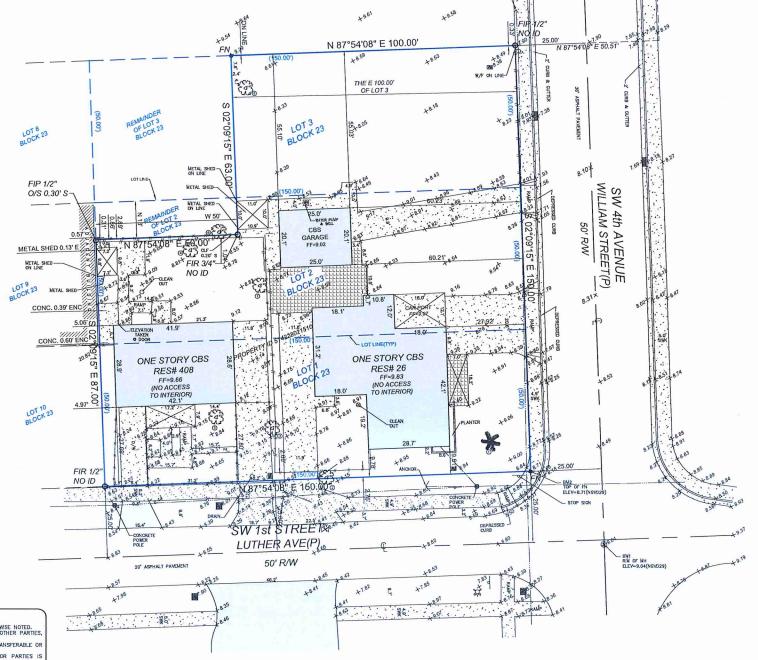

suarez surveying & mapping, inc. 15190 SW 136th Street, Suite 20, Miami, Florida 33196 Tel: 305.596.1799 Fax: 305.596.1886 www.suarezsurveying.com

ABBREVIATIONS: A = ARC CONDITIONS: AC = AR CONDITIONS PAD BCR = BROWN AND COUNTY RECORDS BM = BENCH MARK BDS = BASS OF BEARNGS COS = CONCRETE BLOCK & STUCCO COS = CANCHASAIN CHB = CHORD BEARNG CHB = CHO
SYMBOLS: ## HANGING BOX ## HANGING BOX ## GUALD MAL ## G
SURFACE: ASPHALT CONCRETE PAKENS BUILDING TILES WOOD COVER

NO	COMMON NAME	DBH (FT)	HEIGHT (FT)	SPREAD (FT)	REMARKS
1	PONYTAIL PALM	6	15	15	
2	OAK	4	35	45	2 TRUNKS
3	PINK TABIBULLIA	0.5	18	8	
4	AVOCADO	3	35	45	
5	PINK TABIBULLIA	0.7	20	10	
6	GUMBO LIMBO	1.2	27	30	
7	TABIBULLIA	0.6	20	15	
8	AVOCADO	1.5	30	20	

ONLY TREES WITH A TRUNK DIAMETER OF 4" OR GREATER MEASURED AT BREAST HEIGHT WERE LOCATED. DBH - DIAMTER AT BREAST HEIGHT

PROPERTY DIS STAZEOZISTO LOT 1, LOT 2, LESS THE WEST 50 FEET OF THE NORTH 13 FEET AND THE EAST 100 FEET OF LOT 3, BLOCK 23, TOWN OF HALLANDALE, ACCORDING TO THE PLAT THEREOF AS RECORDED IN PLAT BOOK B AT PAGE 13, OF THE PUBLIC RECORDS OF BROWARD COUNTY, FLORIDA, SAID LANDS SITUATE, LYING AND BEING IN BROWARD COUNTY, FLORIDA.

DATE OF SURVEY:
08/19/2020
008 #: 191230166
FILE #: D-1473
PROJECT NAME:
SURVEYS 2020
CAD FILE(R): PETT INC.
PARTY CHEE:
KLAUDEG
SHEET 1 OF 1

UPDATE LEGAL DESCRIPTION, BOUNDARY, TOPOGRAPHIC AND TREE SURVEY 04/23/2021 JOB # 210432729 REVISIONS:

ELEVATION: 8.522 NGVD29 6.97 NAVD88 STR: 27-51-42 SOUARE CUT IN NW CORNER OF CURB INTERSECTION HALLANDALE BCH BLVD & NE 3 AYE. BM, FOUND 46-2000 FOUND GOOD 12-18-2006

PROPERTY ADDRESS: 26 SW 4th AVENUE, HALLANDALE BEACH, 33009 FLORIDA PROPERTY ID: 514228021510

FLOOD ZONE INFORMATION:
BASED ON THE FLOOD INSURANCE RATE MAP OF THE FEDERAL EMERGENCY
MANAGEMENT AGENCY REMSED ON 08/18/14 AND INDEX MAP REVISED ON 08/18/14
THE GRAPHICALLY DEPICTED BUILDING(S) SHOWN ON THIS MAP OF SURVEY IS WITHIN
ZONE X BASE TOOD ELEVATION I./A COMUNITY NAVE & NUMBER HALLANDALE
BEACH 125110 MAP & PANEL NUMBER 12011C0732 SUFFIX H



License No. LS6220